

WORK IN BASEMENT LIMITED TO REPLACEMENT OF PLUMBING RISERS AND DRAINS FROM FLOOR ABOVE.

**HC** BASEMENT REFERENCE FLOOR PLAN  
SCALE: 1/8" = 1'-0"

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Consultant

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**THE UNIVERSITY OF RHODE ISLAND**

THINK BIG WE DO

Project  
**University of Rhode Island DORR HALL BATHROOM RENOVATIONS & DOOR & SIGNAGE REPLACEMENT KINGSTON, RI**



Seals

Issues

Date	Description
12/20/2012	FOR CONSTRUCTION

Revisions

No.	Date	Description
1	12/05/2012	REVIEW

Drawing Title

**REFERENCE FLOOR PLANS**

Issue Date:	12/20/2012
Project No:	KC-R-R001W-2010.001
Scale:	AS NOTED
Project Manager:	MT Production Leader: MS
Project Architect:	MT Peer Reviewer: JM

Drawing Number  
**A2.100**


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 BATHROOM RENOVATIONS &  
 DOOR & SIGNAGE REPLACEMENT  
 KINGSTON, RI**



Issues

Date	Description
12/20/2012	FOR CONSTRUCTION

Revisions

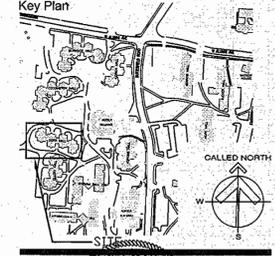No.	Date	Description
1	12/05/2012	REVIEW

Drawing Title  
**REFERENCE  
 & DOOR  
 DEMOLITION  
 FLOOR PLANS**

Issue Date: 12/20/2012  
 Project No: KC-R-RGQW-2010-001 Scale: AS NOTED  
 Project Manager: MT Production Leader: MS  
 Project Architect: MT Peer Reviewer: JM  
 Drawing Number

**A2.101**

**GENERAL DEMOLITION NOTES**


- COORDINATE ALL DEMOLITION WITH NEW CONSTRUCTION REQUIREMENTS
- THE CONTRACTOR SHALL BE RESPONSIBLE FOR THE REMOVAL & LAWFUL DISPOSAL OF ALL MATERIALS AS DESCRIBED.
- PROVIDE TEMPORARY SURFACE PROTECTION DURING REMOVAL OF ITEMS. CONTRACTOR IS RESPONSIBLE FOR ANY SURFACE/FLOOR/FINISH DAMAGE THAT MAY OCCUR.
- MECHANICAL, ELECTRICAL AND OR OTHER WORK RELATED TO A WALL OR AREA SCHEDULED FOR DEMOLITION AND REMOVAL SHALL BE PERFORMED WHETHER SO NOTED OR NOT. PROTECT ALL ITEMS INTENDED FOR SALVAGE AND REUSE OR SCHEDULED TO REMAIN.
- WHERE DOORS AND TRANSOMS ARE SHOWN TO BE DEMOLISHED FRAMES ARE TO REMAIN. PATCH AND REPAIR ANY DAMAGE TO EXISTING DOOR FRAME AND PREPARE FOR INSTALLATION OF NEW DOOR AND TRANSOM. COORDINATE WITH DOOR SCHEDULE.
- REMOVE EXISTING WALL TILE IN BATHTUB.
- REMOVE & DISPOSE OF ALL EXISTING BATHROOM CEILINGS.
- REMOVE & DISPOSE OF RUBBER COVE AT ALL BATHROOM WALLS AND BATHTUB SKIRTS.

**DEMOLITION LEGEND**

--- ITEM TO BE DEMOLISHED

--- EXISTING DOOR AND TRANSOM TO BE REMOVED (AS PER SCHEDULE)

--- EXISTING DOOR AND TRANSOM TO REMAIN (AS PER SCHEDULE)

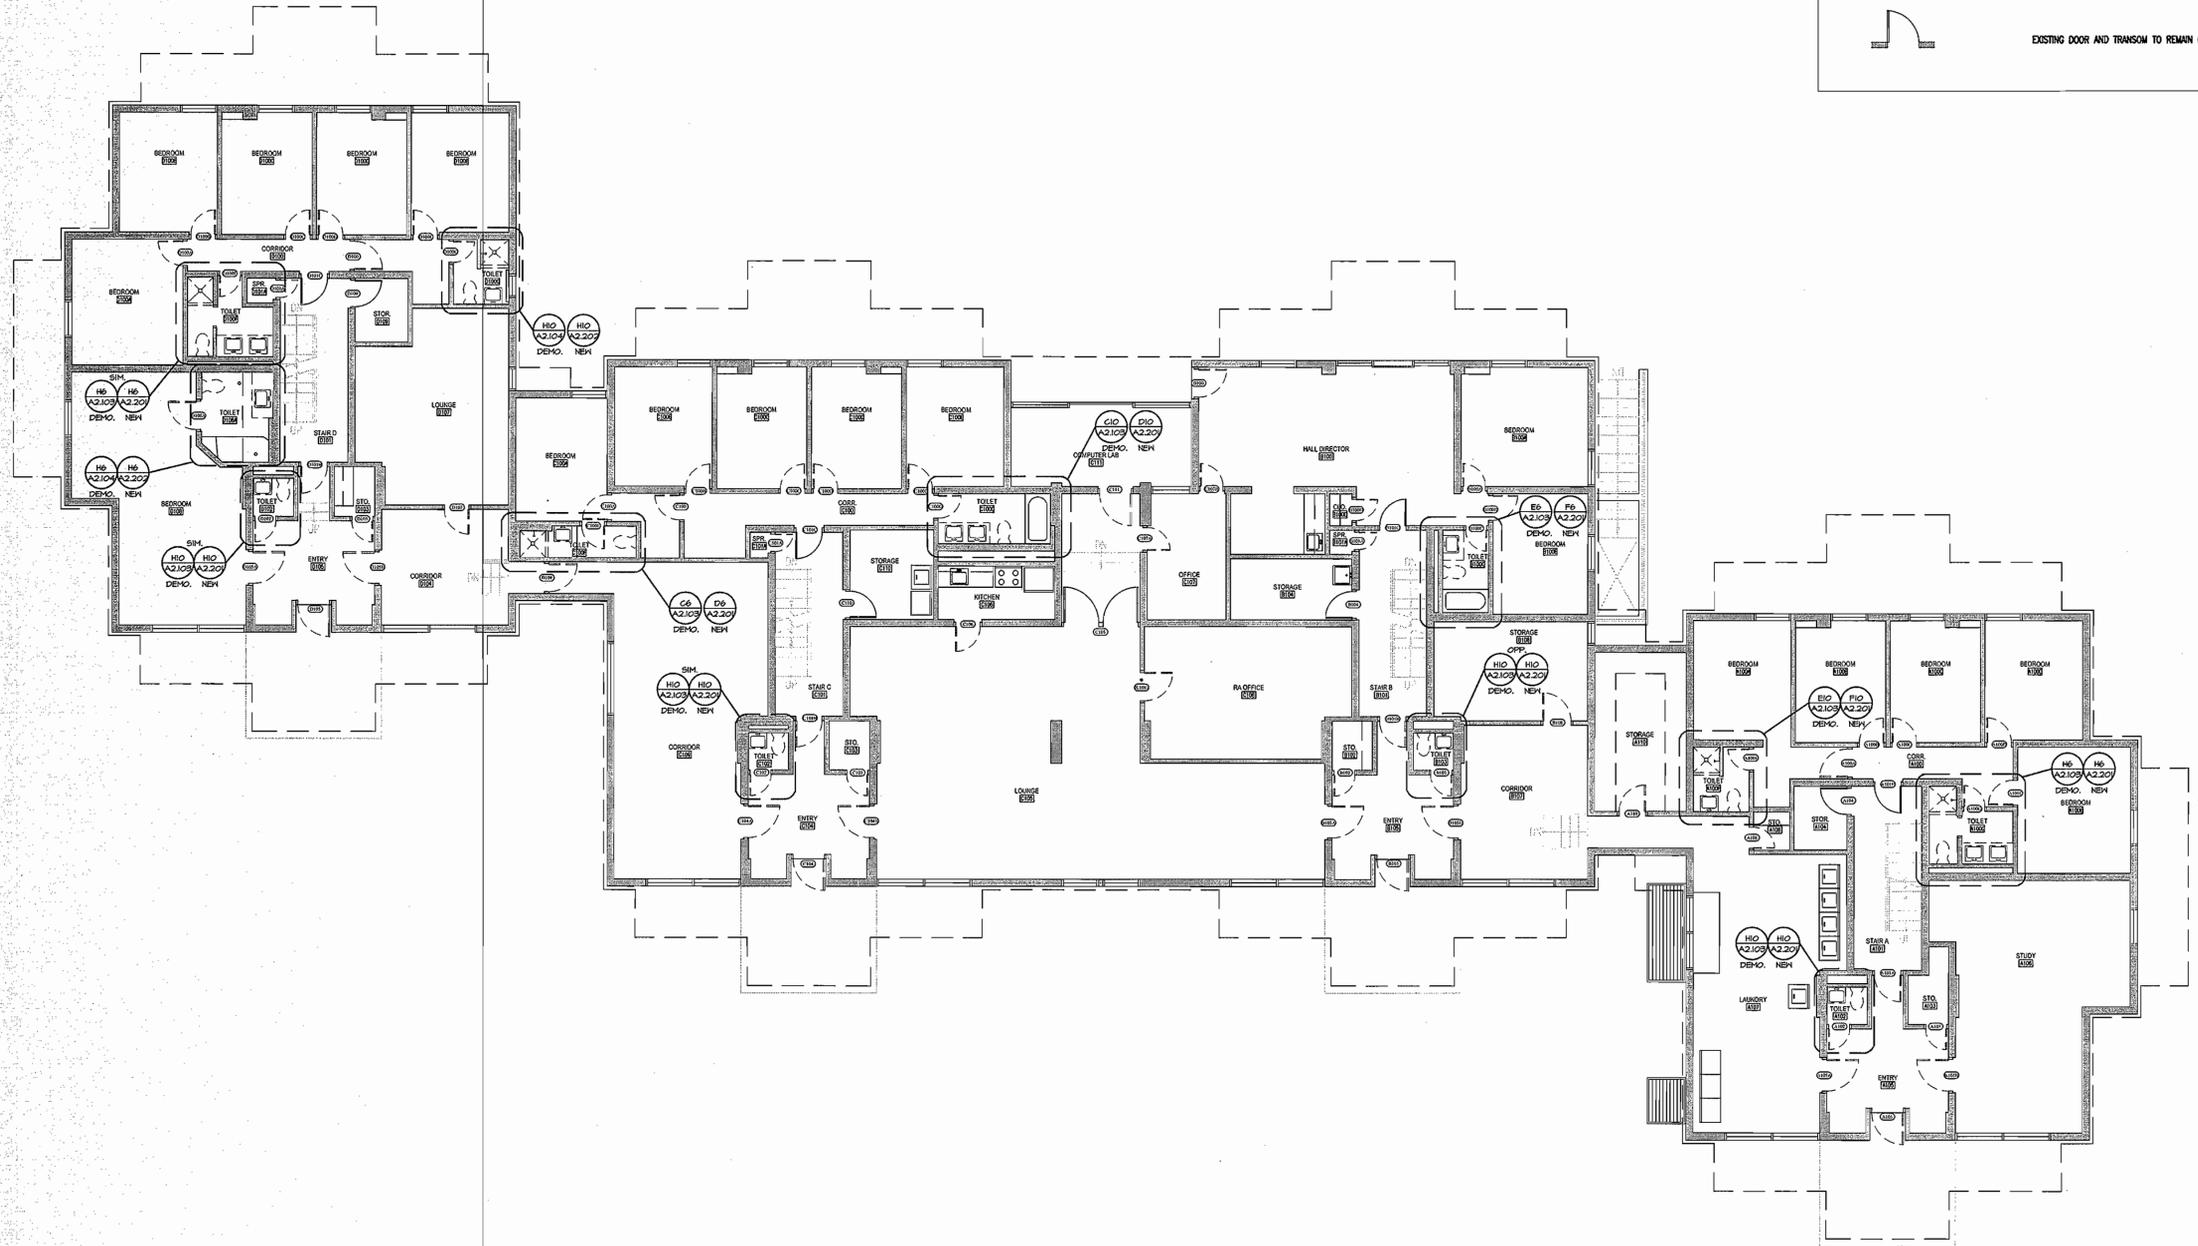

**HIC** GROUND LEVEL REFERENCE FLOOR PLAN  
 SCALE: 1/8"=1'-0"



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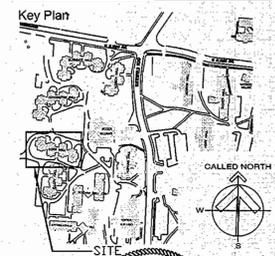


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Project  
**University of Rhode Island DORR HALL BATHROOM RENOVATIONS & DOOR & SIGNAGE REPLACEMENT KINGSTON, RI**



Issues	Date	Description
	12/20/2012	FOR CONSTRUCTION

Revisions	No.	Date	Description
	1	12/05/2012	REVIEW

Drawing Title  
**ENLARGED BATHROOM DEMOLITION FLOOR PLANS**

Issue Date: 12/20/2012  
 Project No: KG-F-ROGW-2010-001 Scale: AS NOTED  
 Project Manager: MT Production Leader: MS  
 Project Architect: MT Peer Reviewer: JM  
 Drawing Number

**A2.103**

**GENERAL DEMOLITION NOTES**


- COORDINATE ALL DEMOLITION WITH NEW CONSTRUCTION REQUIREMENTS
- THE CONTRACTOR SHALL BE RESPONSIBLE FOR THE REMOVAL & LAWFUL DISPOSING OF ALL MATERIALS AS DESCRIBED.
- PROVIDE TEMPORARY SURFACE PROTECTION DURING REMOVAL OF ITEMS. CONTRACTOR IS RESPONSIBLE FOR ANY SURFACE/FLOOR/FINISH DAMAGE THAT MAY OCCUR.
- MECHANICAL, ELECTRICAL AND/OR OTHER WORK RELATED TO A WALL OR AREA SCHEDULED FOR DEMOLITION AND REMOVAL SHALL BE PERFORMED WHETHER SO NOTED OR NOT. PROTECT ALL ITEMS INTENDED FOR SALVAGE AND REUSE OR SCHEDULED TO REMAIN.
- WHERE DOORS AND TRANSOMS ARE SHOWN TO BE DEMOLISHED FRAMES ARE TO REMAIN. PATCH AND REPAIR ANY DAMAGE TO EXISTING DOOR FRAME AND PREPARE FOR INSTALLATION OF NEW DOOR. COORDINATE WITH DOOR SCHEDULE.
- REMOVE EXISTING WALL TILE IN BATHUB WALL
- REMOVE & DISPOSE OF ALL EXISTING BATHROOM CEILING.
- REMOVE & DISPOSE OF RUBBER COVE AT ALL BATHROOM WALLS AND BATHRUB SKIRTS.

**DEMOLITION KEY NOTES**


- REMOVE & DISPOSE OF EXISTING TOILETS, LAVATORIES, FAUCETS, COUNTERS AND CABINETS.
- REMOVE AND RELOCATE EXISTING LIGHT SWITCH AS REQUIRED. REFER TO (E) DRAWINGS.
- REMOVE EXHAUST GRILLE IN CEILING. CLEAN AND VACUUM EXHAUST DUCT. CLEAN & STORE EXHAUST GRILL FOR REINSTALLATION WITH NEW CEILING.
- SANDBLAST PAINTED CONCRETE FLOOR & PREPARE FOR NEW FLOOR INSTALLATION.
- REMOVE & DISPOSE OF EXISTING LIGHT FIXTURES.
- REMOVE & DISPOSE OF EXISTING DOOR FRAMES @ WATER CLOSET FRAMED OPENINGS. SECURE & PREPARE WALL FOR NEW FRAMED OPENING. PATCH PLASTER SMOOTH FINISH AT OPENING PERIMETER.
- REMOVE & DISPOSE OF EXISTING TOWEL BARS, TOILET PAPER DISPENSER AND MIRRORS. PATCH HOLES IN WALL.
- REMOVE & DISPOSE OF EXISTING SHOWER ROD AND CURTAIN.
- REMOVE & DISPOSE OF EXISTING SHOWER VALVES, DRAINS & SHOWERHEADS. **NOTE: WORK TO BE PERFORMED BY BATHFITTERS**
- REMOVE & DISPOSE OF EXISTING FIBERGLASS SHOWER BASIN. **NOTE: WORK TO BE PERFORMED BY BATHFITTERS**
- REMOVE EXISTING FLOOR DRAIN AND PREPARE FOR NEW FLOOR DRAIN.
- (ALTERNATE #1) CORE DRILL EXISTING CONCRETE SLAB TO PREPARE FOR NEW FLOOR DRAIN. COORDINATE SIZE AND LOCATION WITH P-DRAWINGS AND FINISHES.
- REMOVE AND SALVAGE HEATER CABINET ENDS AND COVERS FOR REINSTALLATION. **NOTE: APPLIES TO ALL OF FOURTH FLOOR BATHROOMS & D1000.**
- (BASE B2) REMOVE EXISTING DOOR, HINGES AND TRANSOM PANEL FROM FRAME. PREPARE FOR INSTALLATION OF NEW TRANSOM PANEL, DOOR AND DOOR HARDWARE AS PER SCHEDULE.

**DEMOLITION LEGEND**


- ITEM TO BE DEMOLISHED
- EXISTING DOOR AND TRANSOM TO BE REMOVED (AS PER SCHEDULE)
- EXISTING DOOR AND TRANSOM TO REMAIN (AS PER SCHEDULE)

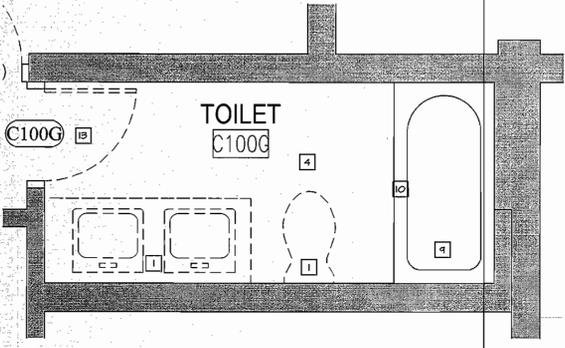


**C100** BATHROOM DEMOLITION PLAN - (C100G)  
 SCALE: 1/2" = 1'-0"

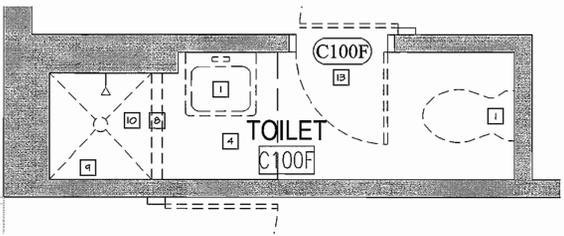


**C6** BATHROOM DEMOLITION PLAN - (C100F)  
 SCALE: 1/2" = 1'-0"

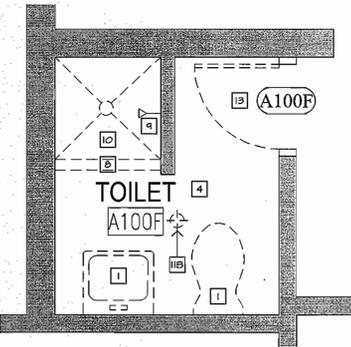


**E10** BATHROOM DEMOLITION PLAN - (A100F)  
 SCALE: 1/2" = 1'-0"

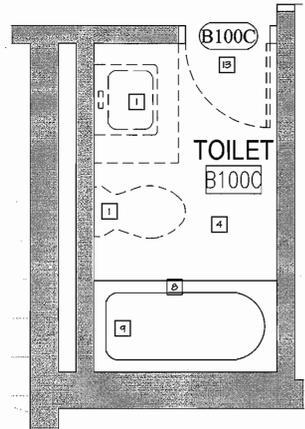


**E6** BATHROOM DEMOLITION PLAN - (B100C)  
 SCALE: 1/2" = 1'-0"

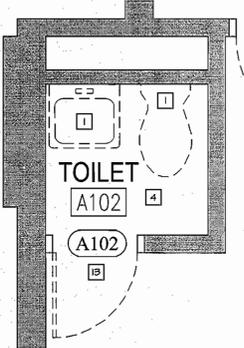


**H10** BATHROOM DEMOLITION PLAN - (A102, B103, C102, D102)  
 SCALE: 1/2" = 1'-0"

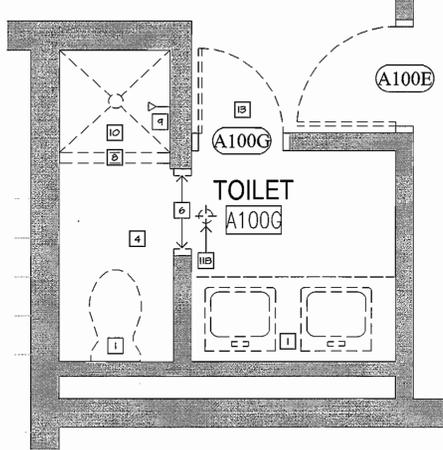


**H6** BATHROOM DEMOLITION PLAN - (A100G, D100F)  
 SCALE: 1/2" = 1'-0"

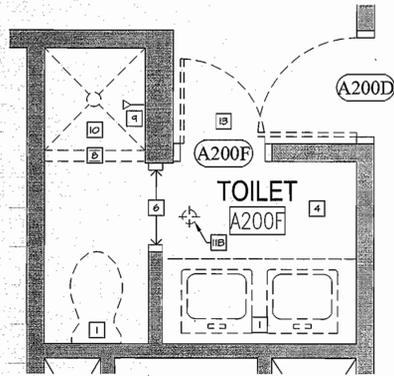


**E10** BATHROOM DEMOLITION PLAN - (A200F, B201F, C200F, D201F)  
SCALE: 1/2" = 1'-0" TYPICAL @ 2ND, 3RD & 4TH FLOORS

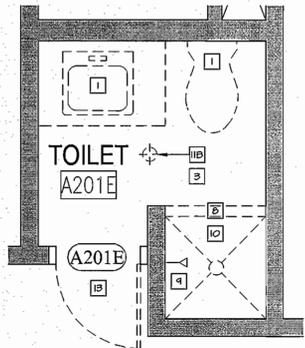


**E10** BATHROOM DEMOLITION PLAN - (A201E, B200F, C201E, D200F)  
SCALE: 1/2" = 1'-0" TYPICAL @ 2ND, 3RD & 4TH FLOORS

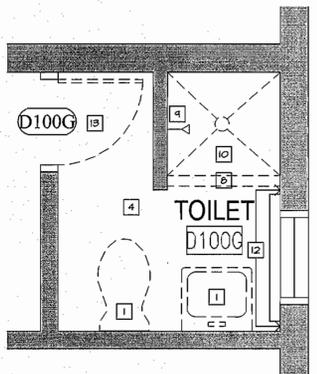

**H10** BATHROOM DEMOLITION PLAN - (D100G)  
SCALE: 1/2" = 1'-0"

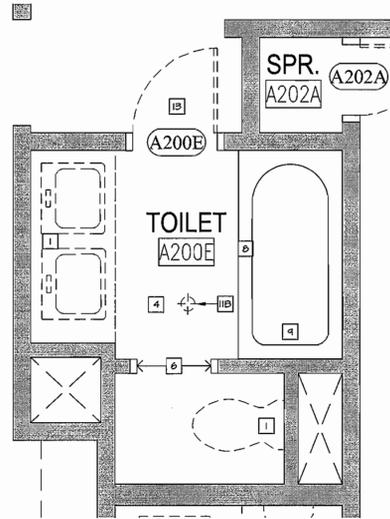

**E7** BATHROOM DEMOLITION PLAN - (A200E, A201F, B200E, B201G, C200E, C201F, D200E, D201G)  
SCALE: 1/2" = 1'-0" TYPICAL @ 2ND, 3RD & 4TH FLOORS

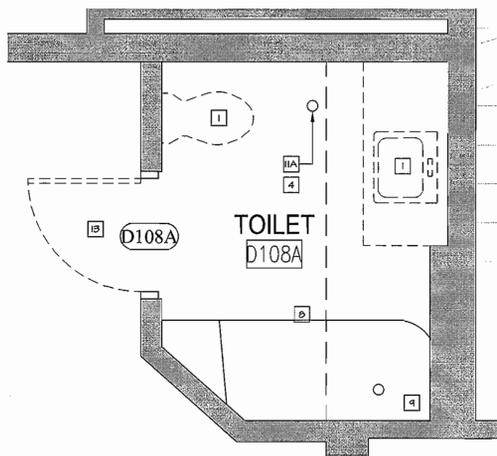

**H7** BATHROOM DEMOLITION PLAN - (D108A)  
SCALE: 1/2" = 1'-0"


**GENERAL DEMOLITION NOTES**

- COORDINATE ALL DEMOLITION WITH NEW CONSTRUCTION REQUIREMENTS
- THE CONTRACTOR SHALL BE RESPONSIBLE FOR THE REMOVAL & LAWFUL DISPOSING OF ALL MATERIALS AS DESCRIBED.
- PROVIDE TEMPORARY SURFACE PROTECTION DURING REMOVAL OF ITEMS. CONTRACTOR IS RESPONSIBLE FOR ANY SURFACE/FLOOR/FINISH DAMAGE THAT MAY OCCUR.
- MECHANICAL, ELECTRICAL AND/OR OTHER WORK RELATED TO A WALL OR AREA SCHEDULED FOR DEMOLITION AND REMOVAL SHALL BE PERFORMED WHETHER SO NOTED OR NOT. PROTECT ALL ITEMS INTENDED FOR SALVAGE AND REUSE OR SCHEDULED TO REMAIN.
- WHERE DOORS AND TRANSOMS ARE SHOWN TO BE DEMOLISHED FRAMES ARE TO REMAIN. PATCH AND REPAIR ANY DAMAGE TO EXISTING DOOR FRAME AND PREPARE FOR INSTALLATION OF NEW DOOR. COORDINATE WITH DOOR SCHEDULE.
- REMOVE EXISTING WALL TILE IN BATHROOM WALL.
- REMOVE & DISPOSE OF ALL EXISTING BATHROOM CEILING.
- REMOVE & DISPOSE OF RUBBER COVE AT ALL BATHROOM WALLS AND BATHRUB SKIRTS.

**DEMOLITION KEY NOTES**

- REMOVE & DISPOSE OF EXISTING TOILETS, LAVATORIES, FAUCETS, COUNTERS AND CABINETS.
- REMOVE AND RELOCATE EXISTING LIGHT SWITCH AS REQUIRED. REFER TO (E) DRAWINGS.
- REMOVE EXHAUST GRILLE IN CEILING. CLEAN AND VACUUM EXHAUST DUCT. CLEAN & STORE EXHAUST GRILL FOR REINSTALLATION WITH NEW CEILING.
- SANDBLAST PAINTED CONCRETE FLOOR & PREPARE FOR NEW FLOOR INSTALLATION.
- REMOVE & DISPOSE OF EXISTING LIGHT FIXTURES.
- REMOVE & DISPOSE OF EXISTING DOOR FRAMES @ WATER CLOSET FRAMED OPENINGS. SECURE & PREPARE WALL FOR NEW FRAMED OPENING. PATCH PLASTER SMOOTH FINISH AT OPENING PERIMETER.
- REMOVE & DISPOSE OF EXISTING TOWEL BARS, TOILET PAPER DISPENSER AND MIRRORS. PATCH HOLES IN WALL.
- REMOVE & DISPOSE OF EXISTING SHOWER ROD AND CURTAIN.
- REMOVE & DISPOSE OF EXISTING SHOWER VALVES, DRAINS & SHOWERHEADS. NOTE: WORK TO BE PERFORMED BY BATHFITTERS
- REMOVE & DISPOSE OF EXISTING FIBERGLASS SHOWER BASIN. NOTE: WORK TO BE PERFORMED BY BATHFITTERS
- REMOVE EXISTING FLOOR DRAIN AND PREPARE FOR NEW FLOOR DRAIN.
- (ALTERNATE #1) CORE DRILL EXISTING CONCRETE SLAB TO PREPARE FOR NEW FLOOR DRAIN. COORDINATE SIZE AND LOCATION WITH P-DRAWINGS AND FINISHES.
- REMOVE AND SALVAGE HEATER CABINET ENDS AND COVERS FOR REINSTALLATION. NOTE: APPLIES TO ALL OF FOURTH FLOOR BATHROOMS & D100G.
- (BASE BID) REMOVE EXISTING DOOR, HINGES AND TRANSOM PANEL FROM FRAME. PREPARE FOR INSTALLATION OF NEW TRANSOM PANEL, DOOR AND DOOR HARDWARE AS PER SCHEDULE.

**DEMOLITION LEGEND**

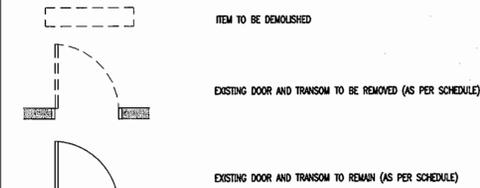

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Consultant




Owner

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Project  
**University of Rhode Island  
DORR HALL  
BATHROOM RENOVATIONS &  
DOOR & SIGNAGE REPLACEMENT  
KINGSTON, RI**



Seals

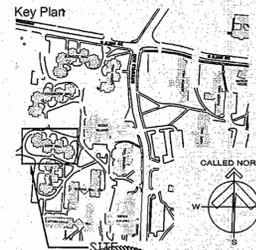

Issues	
Date	Description
12/20/2012	FOR CONSTRUCTION

Revisions		
No.	Date	Description
1	12/05/2012	REVIEW

Drawing Title  
**ENLARGED  
BATHROOM  
DEMOLITION  
FLOOR PLANS**

Issue Date: 12/20/2012

Project No: KC-F-ROGW-2010-001 Scale: AS NOTED

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Project Architect: MT Peer Reviewer: JM

Drawing Number

**A2.104**

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Project  
**University of Rhode Island DORR HALL BATHROOM RENOVATIONS & DOOR & SIGNAGE REPLACEMENT KINGSTON, RI**



Issues

Date	Description
12/20/2012	FOR CONSTRUCTION

Revisions

No.	Date	Description
1	12/05/2012	REVIEW

Drawing Title  
**BATHROOM CONSTRUCTION FLOOR PLANS**


Issue Date: 12/20/2012  
 Project No: KC-R-ROGW-2010-001 Scale: AS NOTED  
 Project Manager: MT Production Leader: MS  
 Project Architect: MT Peer Reviewer: JM

Drawing Number  
**A2.201**


- CONSTRUCTION NOTES**
- 1 PREPARE SUBFLOOR AND INSTALL NEW 2X2 CERAMIC TILE FLOORING & COVE.
  - 2 INSTALL NEW SOLID SURFACE COUNTER, BACK SPLASH, SIDE SPLASH AND INTEGRAL SINKS. CONNECT TO EXISTING SUPPLY AND DRAIN.
  - 2A INSTALL NEW WALL MOUNTED SINK CONNECT TO EXISTING SUPPLY AND DRAIN.
  - 3 INSTALL NEW FAUCETS AND VALVES.
  - 4 INSTALL FIBER REINFORCED PANELS FLOOR TO UNDERSIDE OF DECK ON ALL BATHROOM WALLS (EXCEPT @ SHOWER & BATHTUB STALLS - SEE ALSO DETAIL B10/A2.201).
  - 5 INSTALL NEW TOILET AND RECONNECT TO SUPPLY AND DRAIN.
  - 6 INSTALL NEW BATHTUBS DRAIN, VALVE AND SHOWERHEAD. (WORK TO BE PERFORMED BY BATHTUBS).
  - 7 INSTALL NEW BATHTUBS SHOWER ENCLOSURES INCLUDING SHOWER PAN, WALL INSERTS & CEILING. (WORK TO BE PERFORMED BY BATHTUBS).
  - 8 INSTALL NEW BATHTUBS BATHTUB LINER & WALL INSERTS. (WORK TO BE PERFORMED BY BATHTUBS).
  - 9 INSTALL NEW DRAIN. (WORK TO BE PERFORMED BY BATHTUBS).
  - 10 INSTALL NEW STAINLESS STEEL ROBE HOOKS @ 6'-0" AFF. REFER TO INTERIOR ELEVATIONS - A5.201/A5.202 FOR LOCATIONS.
  - 11 PROVIDE AND INSTALL ONE WALL MOUNTED UP/DOWN FLUORESCENT LIGHT FIXTURE ABOVE SINK AND ONE CEILING MOUNTED LIGHT FIXTURE IN FRONT OF SHOWER (SEE REFLECTED CEILING PLAN). INSTALLATION INCLUDES WIREMOLD, WIRE AND SWITCH.
  - 12 FURNISH AND INSTALL ONE 16" DEEP HEAVY DUTY, PLASTIC COATED METAL WIRE SHELF SET 8" A.F.F.
  - 13 REINSTALL EXHAUST GRILLE IN CEILING.
  - 14 INSTALL NEW SHOWER ROD AND CURTAIN AT EXISTING HEIGHT.
  - 15 INSTALL ACCESS PANELS, REPLACE DAMAGED UNITS. (CONTINGENCY ALLOWANCE)
  - 16 INSTALL NEW DOOR AND TRANSOM AS PER SCHEDULE. PATCH AND REPAIR EXISTING DOOR FRAME AND PAINT.
  - 17 INSTALL NEW FLOOR DRAIN. - COORDINATE WITH P-DRAWINGS AND FINISHES.

- TOILET ACCESSORIES**
- AC-1 TOILET PAPER HOLDER. TO BE PROVIDED BY OWNER AND INSTALLED BY CONTRACTOR.
  - AC-2 STAINLESS STEEL, SATIN FINISH SHOWER ROD & MOUNTING BRACKETS.
  - AC-3 SHOWER CURTAIN AND SHOWER CURTAIN RINGS
  - AC-4 NEW HEAVY DUTY METAL WIRE SHELF - MOUNTED 8" A.F.F.
  - AC-5 NEW STAINLESS STEEL ROBE HOOKS MTD. 6'-0" A.F.F.
  - AC-6 NEW FRAMELESS MIRROR - REFER TO INTERIOR ELEVATIONS - A5.201/A5.202 FOR SIZING.
  - AC-7 8" DEEP SOLID SURFACE PLASTIC SHELF.


**NOTE:**  
 1. BATHTUBS INSTALLATION TO BE DONE LAST.

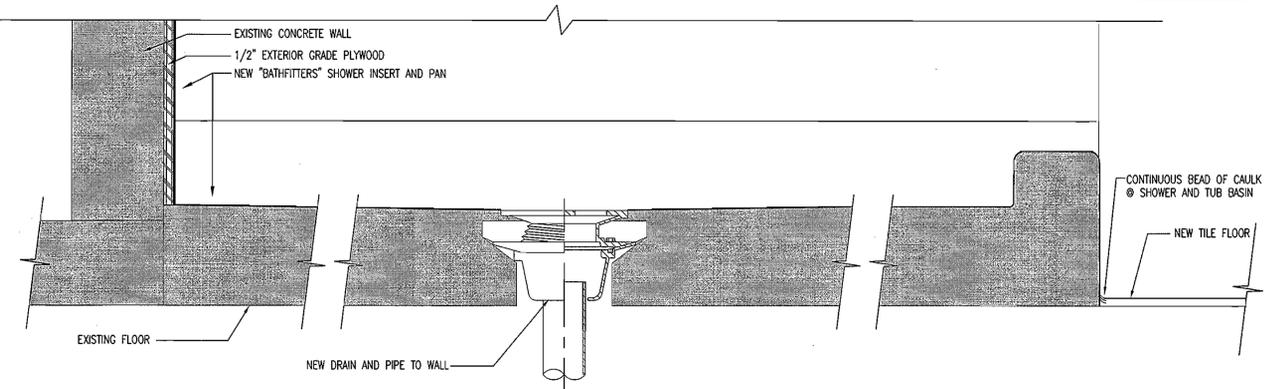


**B6 SHOWER DRAIN DETAIL**  
 SCALE: 6" = 1'-0"

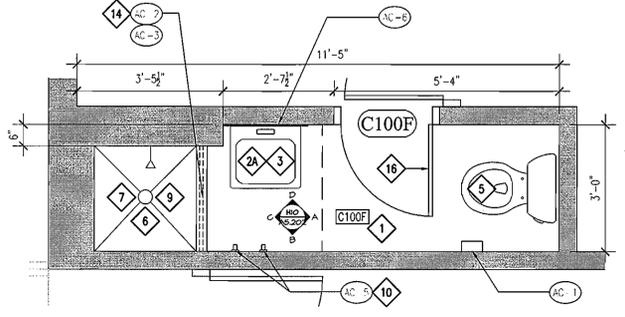


**D6 BATHROOM FLOOR PLAN - (C100F)**  
 SCALE: 1/2" = 1'-0"

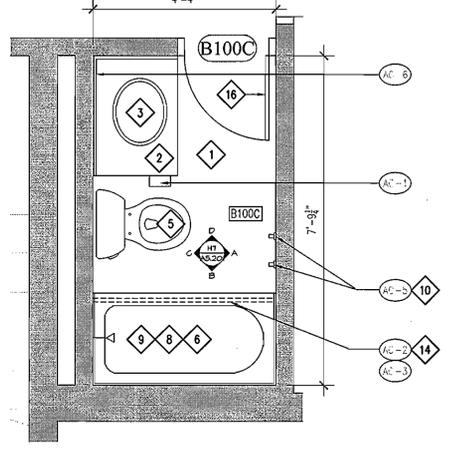


**F6 BATHROOM FLOOR PLAN - (B100C)**  
 SCALE: 1/2" = 1'-0"

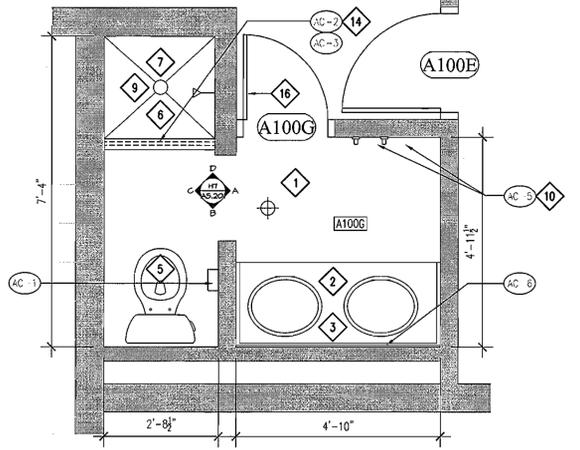


**H6 BATHROOM FLOOR PLAN - (A100G, D100F)**  
 SCALE: 1/2" = 1'-0"

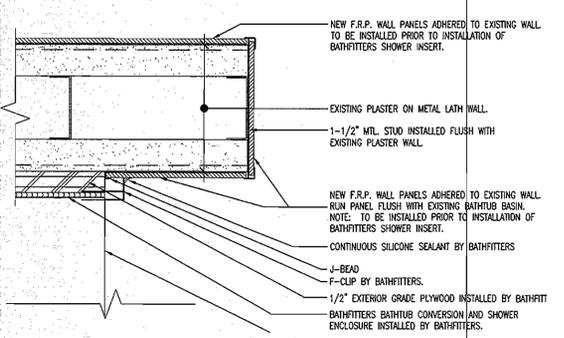


**B10 F.R.P. END PANEL @ BATHTUBS SHOWER ENCLOSURE**  
 SCALE: 6" = 1'-0"

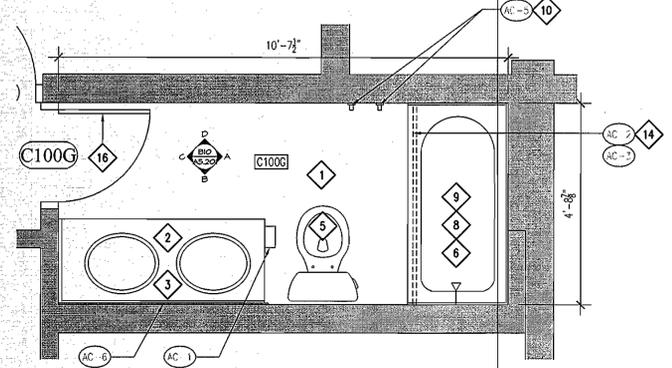


**D10 BATHROOM FLOOR PLAN - (C100G)**  
 SCALE: 1/2" = 1'-0"

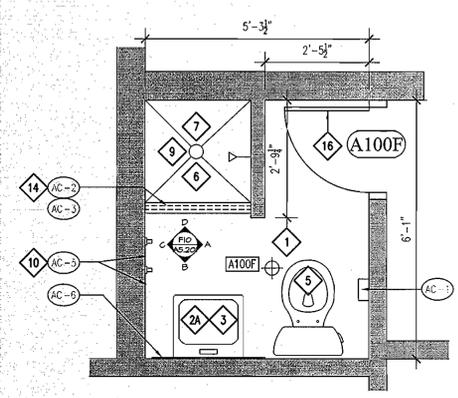


**F10 BATHROOM FLOOR PLAN - (A100F)**  
 SCALE: 1/2" = 1'-0"

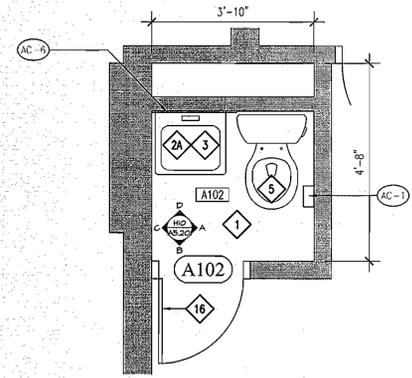


**H10 BATHROOM FLOOR PLAN - (A102, B103, C102, C102)**  
 SCALE: 1/2" = 1'-0"

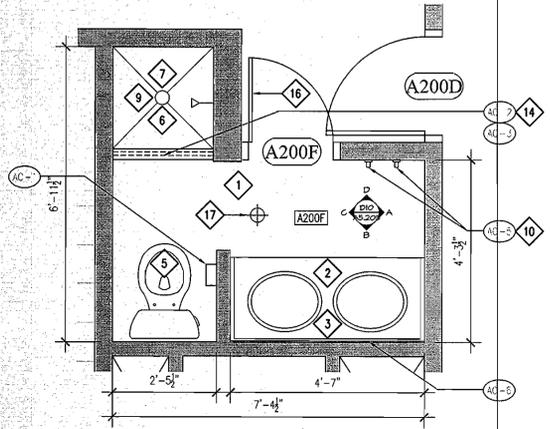


**E10** BATHROOM FLOOR PLAN - (A200F, B201F, C200F, D201F)  
SCALE: 1/2" = 1'-0" TYPICAL @ 2ND, 3RD & 4TH FLOORS

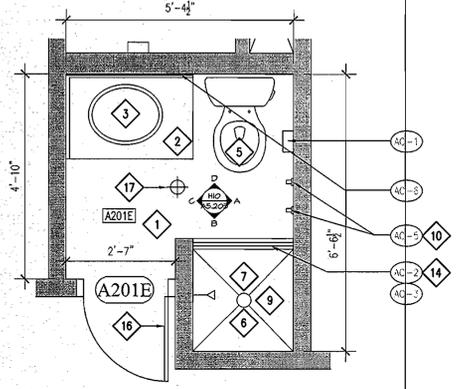


**E10** BATHROOM FLOOR PLAN - A201E, B200F, C201E, D200F)  
SCALE: 1/2" = 1'-0" TYPICAL @ 2ND, 3RD & 4TH FLOORS

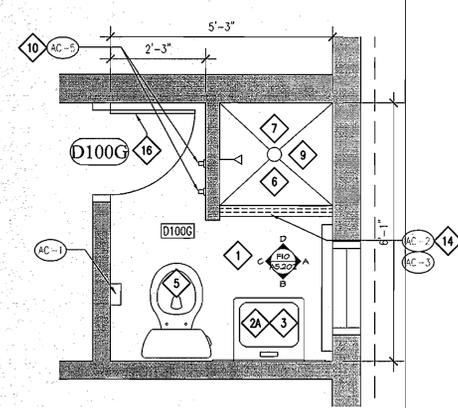

**H10** BATHROOM FLOOR PLAN - (D100G)  
SCALE: 1/2" = 1'-0"

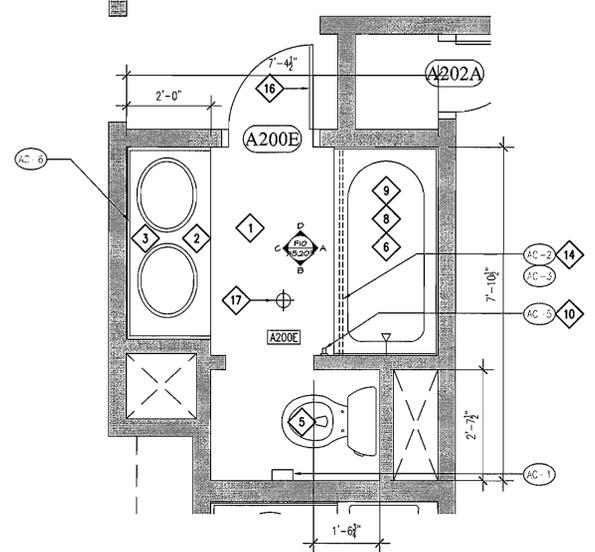

**E6** BATHROOM FLOOR PLAN - (A200E, A201F, B200E, B201G, C200E, C201F, D200E, D201G)  
SCALE: 1/2" = 1'-0" TYPICAL @ 2ND, 3RD & 4TH FLOORS

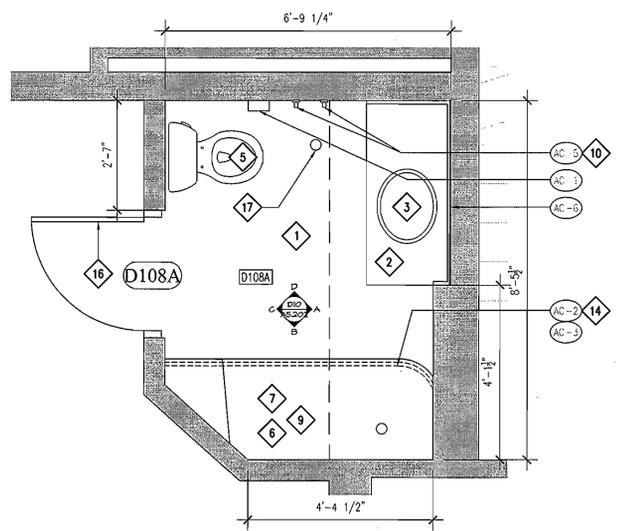

**H6** BATHROOM FLOOR PLAN - (D108A)  
SCALE: 1/2" = 1'-0"

- CONSTRUCTION NOTES**
- 1 PREPARE SUBFLOOR AND INSTALL NEW 2X2 CERAMIC TILE FLOORING & COVE.
  - 2 INSTALL NEW SOLID SURFACE COUNTER, BACK SPLASH, SIDE SPLASH AND INTEGRAL SINKS. CONNECT TO EXISTING SUPPLY AND DRAIN.
  - 2A INSTALL NEW WALL MOUNTED SINK CONNECT TO EXISTING SUPPLY AND DRAIN.
  - 3 INSTALL NEW FAUCETS AND VALVES.
  - 4 INSTALL FIBER REINFORCED PANELS FLOOR TO UNDERSIDE OF DECK ON ALL BATHROOM WALLS (EXCEPT SHOWER & BATHTUB STALLS - SEE ALSO DETAIL B10/A2.201).
  - 5 INSTALL NEW TOILET AND RECONNECT TO SUPPLY AND DRAIN.
  - 6 INSTALL NEW BATHTUB DRAIN, VALVE AND SHOWERHEAD. (WORK TO BE PERFORMED BY BATHTUBTERS).
  - 7 INSTALL NEW BATHTUB SHOWER ENCLOSURES INCLUDING SHOWER PAN, WALL INSERTS & CEILING. (WORK TO BE PERFORMED BY BATHTUBTERS).
  - 8 INSTALL NEW BATHTUBTERS BATHTUB LINER & WALL INSERTS. (WORK TO BE PERFORMED BY BATHTUBTERS).
  - 9 INSTALL NEW DRAIN. (WORK TO BE PERFORMED BY BATHTUBTERS).
  - 10 INSTALL NEW STAINLESS STEEL ROBE HOOKS @ 6'-0" AFF. REFER TO INTERIOR ELEVATIONS - A5.201/A5.202 FOR LOCATIONS.
  - 11 PROVIDE AND INSTALL ONE WALL MOUNTED UP/DOWN FLUORESCENT LIGHT FIXTURE ABOVE SINK AND ONE CEILING MOUNTED LIGHT FIXTURE IN FRONT OF SHOWER (SEE REFLECTED CEILING PLAN). INSTALLATION INCLUDES WIREWELD, WIRE AND SWITCH.
  - 12 FURNISH AND INSTALL ONE 16" DEEP HEAVY DUTY, PLASTIC COATED METAL WIRE SHELF @ 8" A.F.F.
  - 13 REINSTALL EXHAUST GRILLE IN CEILING.
  - 14 INSTALL NEW SHOWER ROD AND CURTAIN AT EXISTING HEIGHT.
  - 15 INSTALL ACCESS PANELS. REPLACE DAMAGED UNITS. (CONTINGENCY ALLOWANCE)
  - 16 INSTALL NEW DOOR AND TRANSOM AS PER SCHEDULE. PATCH AND REPAIR EXISTING DOOR FRAME AND PAINT.
  - 17 INSTALL NEW FLOOR DRAIN - COORDINATE WITH P-DRAWINGS AND FINISHES.

- TOILET ACCESSORIES**
- AC-1 TOILET PAPER HOLDER. TO BE PROVIDED BY OWNER AND INSTALLED BY CONTRACTOR.
  - AC-2 STAINLESS STEEL, SATIN FINISH SHOWER ROD & MOUNTING BRACKETS.
  - AC-3 SHOWER CURTAIN AND SHOWER CURTAIN RINGS
  - AC-4 NEW HEAVY DUTY METAL WIRE SHELF - MOUNTED 8" A.F.F.
  - AC-5 NEW STAINLESS STEEL ROBE HOOKS MTD. 6'-0" A.F.F.
  - AC-6 NEW FRAMELESS MIRROR - REFER TO INTERIOR ELEVATIONS - A5.201/5.202 FOR SIZING.
  - AC-7 8" DEEP SOLID SURFACE PLASTIC SHELF.

**NOTE:**  
1. BATHTUBTERS INSTALLATION TO BE DONE LAST.



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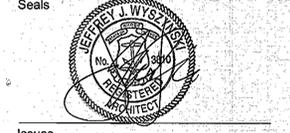
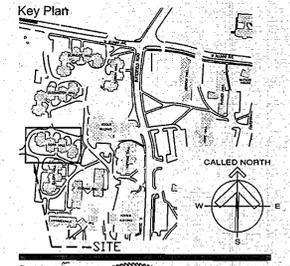
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Project  
**University of Rhode Island DORR HALL BATHROOM RENOVATIONS & DOOR & SIGNAGE REPLACEMENT KINGSTON, RI**



**ISSUES**

Date	Description
12/20/2012	FOR CONSTRUCTION


**Revisions**

No.	Date	Description
1	12/05/2012	REVIEW


Drawing Title  
**BATHROOM CONSTRUCTION FLOOR PLANS**

Issue Date: 12/20/2012  
Project No.: KC-R-ROGW-2010.001 Scale: AS NOTED  
Project Manager: MT Production Leader: MS  
Project Architect: MT Peer Reviewer: JM  
Drawing Number


**A2.202**

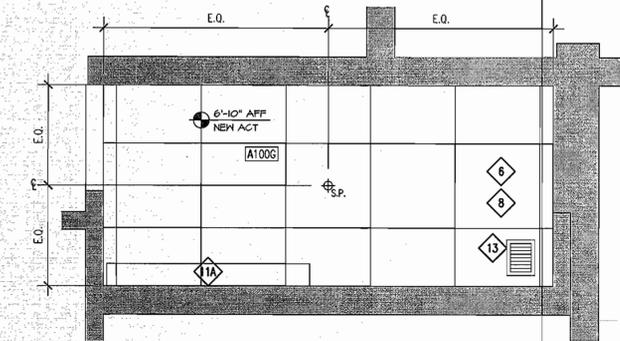


**D10** BATHROOM REFLECTED CEILING PLAN - (C100G)  
SCALE: 1/2" = 1'-0"

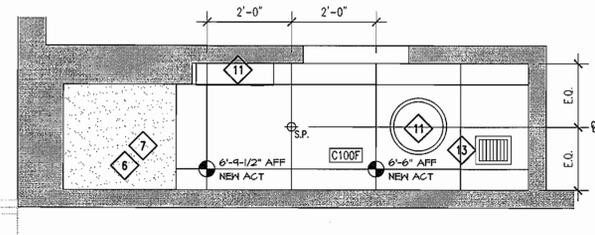


**D6** BATHROOM REFLECTED CEILING PLAN - (C100F)  
SCALE: 1/2" = 1'-0"

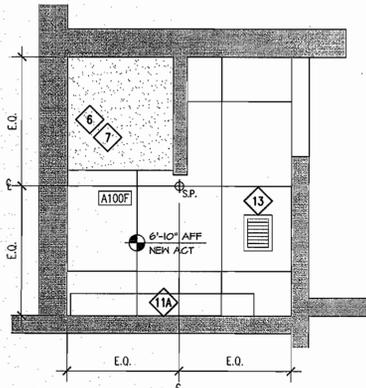


**F10** BATHROOM REFLECTED CEILING PLAN - (A100F)  
SCALE: 1/2" = 1'-0"

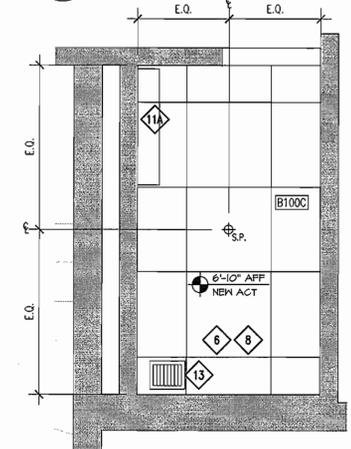

**F6** BATHROOM REFLECTED CEILING PLAN - (B100C)  
SCALE: 1/2" = 1'-0"

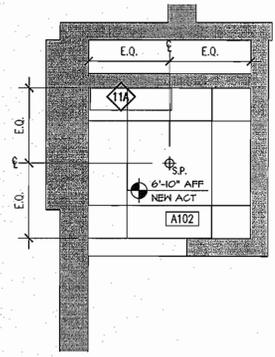

**H10** BATHROOM REFLECTED CEILING PLAN - (A102, B103, C102, D102)  
SCALE: 1/2" = 1'-0"

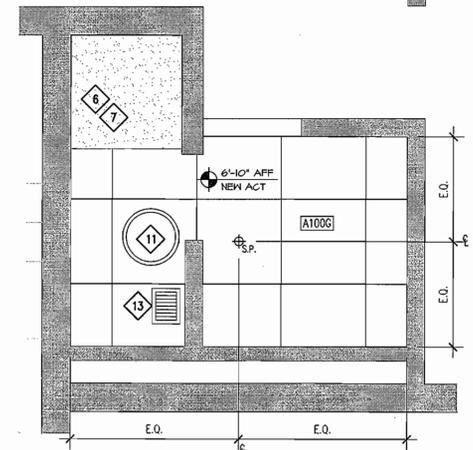

**H6** BATHROOM REFLECTED CEILING PLAN - (A100G, D100F)  
SCALE: 1/2" = 1'-0"


**CONSTRUCTION NOTES**

- 1 PREPARE SUBFLOOR AND INSTALL NEW 2X2 CERAMIC TILE FLOORING & COVE.
- 2 INSTALL NEW SOLID SURFACE COUNTER, BACK SPLASH, SIDE SPLASH AND INTEGRAL SINKS. CONNECT TO EXISTING SUPPLY AND DRAIN.
- 2A INSTALL NEW WALL MOUNTED SINK CONNECT TO EXISTING SUPPLY AND DRAIN.
- 3 INSTALL NEW FAUCETS AND VALVES.
- 4 INSTALL FIBER REINFORCED PANELS FLOOR TO UNDERSIDE OF DECK ON ALL BATHROOM WALLS (EXCEPT @ SHOWER & BATHUB STALLS - SEE ALSO DETAIL B10/A2.201).
- 5 INSTALL NEW TOILET AND RECONNECT TO SUPPLY AND DRAIN.
- 6 INSTALL NEW BATHFITTERS DRAIN, VALVE AND SHOWERHEAD. (WORK TO BE PERFORMED BY BATHFITTERS).
- 7 INSTALL NEW BATHFITTERS SHOWER ENCLOSURES INCLUDING SHOWER PAN, WALL INSERTS & CEILING. (WORK TO BE PERFORMED BY BATHFITTERS).
- 8 INSTALL NEW BATHFITTERS BATHUB LINER & WALL INSERTS. (WORK TO BE PERFORMED BY BATHFITTERS).
- 9 INSTALL NEW DRAIN. (WORK TO BE PERFORMED BY BATHFITTERS).
- 10 INSTALL NEW STAINLESS STEEL ROBE HOOKS @ 6'-0" AFF. REFER TO INTERIOR ELEVATIONS - AS.201/AS.202 FOR LOCATIONS.
- 11 PROVIDE AND INSTALL ONE WALL MOUNTED UP/DOWN FLUORESCENT LIGHT FIXTURE ABOVE SINK AND ONE CEILING MOUNTED LIGHT FIXTURE IN FRONT OF SHOWER (SEE REFLECTED CEILING PLAN). INSTALLATION INCLUDES WIREMOLD, WIRE AND SWITCH.
- 11A PROVIDE AND INSTALL ONE WALL MOUNTED UP/DOWN LIGHT FIXTURE ABOVE SINK. (SEE REFLECTED CEILING PLAN). INSTALLATION INCLUDES WIREMOLD, WIRE AND SWITCH.
- 12 FURNISH AND INSTALL ONE 16" DEEP HEAVY DUTY, PLASTIC COATED METAL WIRE SHELF SET 8" A.F.F.
- 13 REINSTALL EXHAUST GRILLE IN CEILING.
- 14 INSTALL NEW SHOWER ROD AND CURTAIN AT EXISTING HEIGHT.
- 15 INSTALL ACCESS PANELS. REPLACE DAMAGED UNITS. (CONTINGENCY ALLOWANCE)
- 16 INSTALL NEW DOOR AND TRANSOM AS PER SCHEDULE. PATCH AND REPAIR EXISTING DOOR FRAME AND PAINT.

**TOILET ACCESSORIES**

- AC-1 TOILET PAPER HOLDER. TO BE PROVIDED BY OWNER AND INSTALLED BY CONTRACTOR.
- AC-2 STAINLESS STEEL, SATIN FINISH SHOWER ROD & MOUNTING BRACKETS.
- AC-3 SHOWER CURTAIN AND SHOWER CURTAIN RINGS.
- AC-4 NEW HEAVY DUTY METAL WIRE SHELF - MOUNTED 8" A.F.F.
- AC-5 NEW STAINLESS STEEL ROBE HOOKS MTD. 6'-0" A.F.F.
- AC-6 NEW FRAMELESS MIRROR - REFER TO INTERIOR ELEVATIONS - AS.201/S.202 FOR SIZING.
- AC-7 8" DEEP SOLID SURFACE PLASTIC SHELF.

**REFLECTED CEILING PLAN LEGEND**

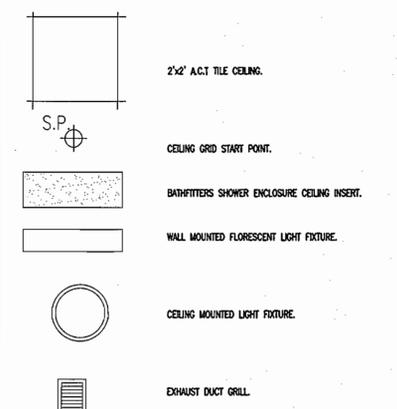

**NOTE:**

1. BATHFITTERS INSTALLATION TO BE DONE LAST.



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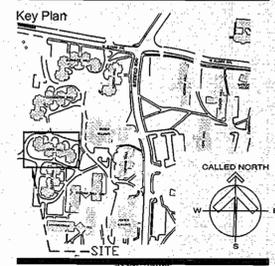


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Project  
**University of Rhode Island DORR HALL BATHROOM RENOVATIONS & DOOR & SIGNAGE REPLACEMENT KINGSTON, RI**



ISSUES

Date	Description
12/20/2012	FOR CONSTRUCTION

Revisions


No.	Date	Description
1	12/05/2012	REVIEW

Drawing Title


**BATHROOM REFLECTED CEILING PLANS**

Issue Date:	12/20/2012
Project No:	KC-R-RCOV-2010-001
Project Manager:	MT
Project Architect:	MT
Drawing Number:	A2.301


Scale: AS NOTED  
Production Leader: MS  
Peer Reviewer: JM

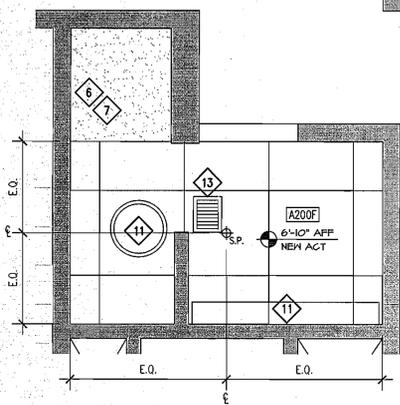


**E10** BATHROOM REFLECTED CEILING PLAN - (A200F, B201F, C200F, D201F)  
SCALE: 1/2" = 1'-0" TYPICAL @ 2ND, 3RD & 4TH FLOORS

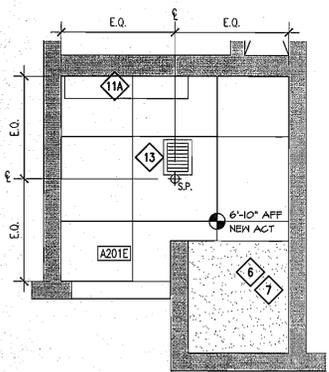


**E10** BATHROOM REFLECTED CEILING PLAN - (A201E, B200F, C201E, D200F)  
SCALE: 1/2" = 1'-0" TYPICAL @ 2ND, 3RD & 4TH FLOORS

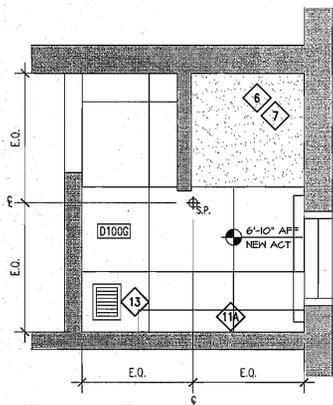

**H10** BATHROOM REFLECTED CEILING PLAN - (D100G)  
SCALE: 1/2" = 1'-0"

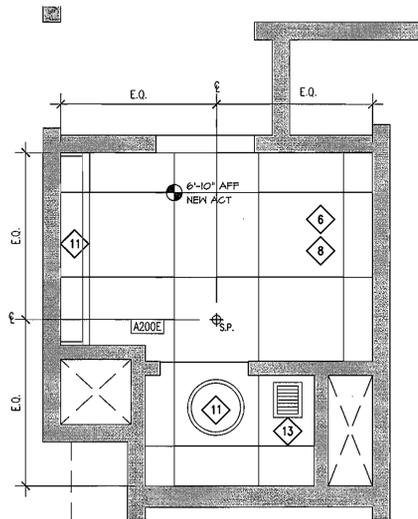

**E6** BATHROOM REFLECTED CEILING PLAN - (A200E, A201F, B200E, B201G, C200E, C201F, D200E, D201G)  
SCALE: 1/2" = 1'-0" TYPICAL @ 2ND, 3RD & 4TH FLOORS

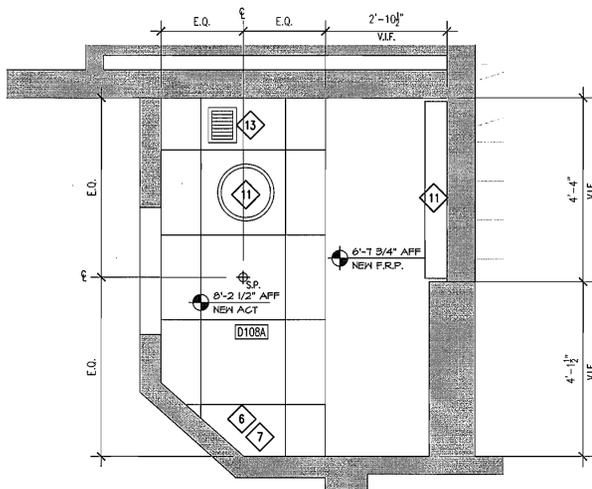

**H6** BATHROOM REFLECTED CEILING PLAN - (D108A)  
SCALE: 1/2" = 1'-0"


CONSTRUCTION NOTES

- 1 PREPARE SUBFLOOR AND INSTALL NEW 2X2 CERAMIC TILE FLOORING & COVE.
- 2 INSTALL NEW SOLID SURFACE COUNTER, BACK SPLASH, SIDE SPLASH AND INTEGRAL SINKS. CONNECT TO EXISTING SUPPLY AND DRAIN.
- 2A INSTALL NEW WALL MOUNTED SINK CONNECT TO EXISTING SUPPLY AND DRAIN.
- 3 INSTALL NEW FAUCETS AND VALVES.
- 4 INSTALL FIBER REINFORCED PANELS FLOOR TO UNDERSIDE OF DECK ON ALL BATHROOM WALLS (EXCEPT @ SHOWER & BATHTUB STALLS - SEE ALSO DETAIL B10/A2.201).
- 5 INSTALL NEW TOILET AND RECONNECT TO SUPPLY AND DRAIN
- 6 INSTALL NEW BATHFITTERS DRAIN, VALVE AND SHOWERHEAD. (WORK TO BE PERFORMED BY BATHFITTERS).
- 7 INSTALL NEW BATHFITTERS SHOWER ENCLOSURES INCLUDING SHOWER PAN, WALL INSERTS & CEILING. (WORK TO BE PERFORMED BY BATHFITTERS)
- 8 INSTALL NEW BATHFITTERS BATHTUB LINER & WALL INSERTS. (WORK TO BE PERFORMED BY BATHFITTERS)
- 9 INSTALL NEW DRAIN. (WORK TO BE PERFORMED BY BATHFITTERS)
- 10 INSTALL NEW STAINLESS STEEL ROBE HOOKS @ 6'-0" AFF. REFER TO INTERIOR ELEVATIONS - AS.201/AS.202 FOR LOCATIONS
- 11 PROVIDE AND INSTALL ONE WALL MOUNTED UP/DOWN FLUORESCENT LIGHT FIXTURE ABOVE SINK AND ONE CEILING MOUNTED LIGHT FIXTURE IN FRONT OF SHOWER (SEE REFLECTED CEILING PLAN). INSTALLATION INCLUDES WIREMOLD, WIRE AND SWITCH
- 11A PROVIDE AND INSTALL ONE WALL MOUNTED UP/DOWN LIGHT FIXTURE ABOVE SINK. (SEE REFLECTED CEILING PLAN). INSTALLATION INCLUDES WIREMOLD, WIRE AND SWITCH
- 12 FURNISH AND INSTALL ONE 16" DEEP HEAVY DUTY, PLASTIC COATED METAL WIRE SHELF SET 8" A.F.F.
- 13 REINSTALL EXHAUST GRILLE IN CEILING.
- 14 INSTALL NEW SHOWER ROD AND CURTAIN AT EXISTING HEIGHT.
- 15 INSTALL ACCESS PANELS. REPLACE DAMAGED UNITS. (CONTINGENCY ALLOWANCE)
- 16 INSTALL NEW DOOR AND TRANSOM AS PER SCHEDULE. PATCH AND REPAIR EXISTING DOOR FRAME AND PAINT.

TOILET ACCESSORIES

- AC-1 TOILET PAPER HOLDER. TO BE PROVIDED BY OWNER AND INSTALLED BY CONTRACTOR.
- AC-2 STAINLESS STEEL, SATIN FINISH SHOWER ROD & MOUNTING BRACKETS.
- AC-3 SHOWER CURTAIN AND SHOWER CURTAIN RINGS
- AC-4 NEW HEAVY DUTY METAL WIRE SHELF - MOUNTED 8" A.F.F.
- AC-5 NEW STAINLESS STEEL ROBE HOOKS MTD. 6'-0" A.F.F.
- AC-6 NEW FRAMELESS MIRROR - REFER TO INTERIOR ELEVATIONS - AS.201/S.202 FOR SIZING.
- AC-7 8" DEEP SOLID SURFACE PLASTIC SHELF.

REFLECTED CEILING PLAN LEGEND

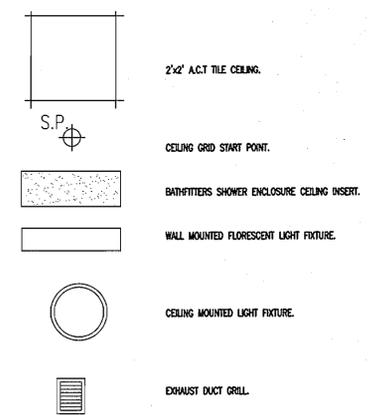

NOTE:

1. BATHFITTERS INSTALLATION TO BE DONE LAST.



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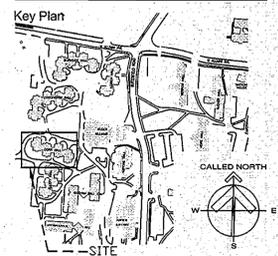


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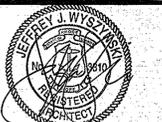
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Project  
**University of Rhode Island  
DORR HALL  
BATHROOM RENOVATIONS &  
DOOR & SIGNAGE REPLACEMENT  
KINGSTON, RI**



Seals



Issues	Date	Description
	12/20/2012	FOR CONSTRUCTION

Revisions	No.	Date	Description
	1	12/05/2012	REVIEW

Revisions	No.	Date	Description
	1	12/05/2012	REVIEW

Revisions	No.	Date	Description
	1	12/05/2012	REVIEW

Drawing Title

**BATHROOM REFLECTED CEILING PLANS**

Issue Date: 12/20/2012


Project No: KC-R-ROGW-2010-001 Scale: AS NOTED

Project Manager: MT Production Leader: MS


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Drawing Number


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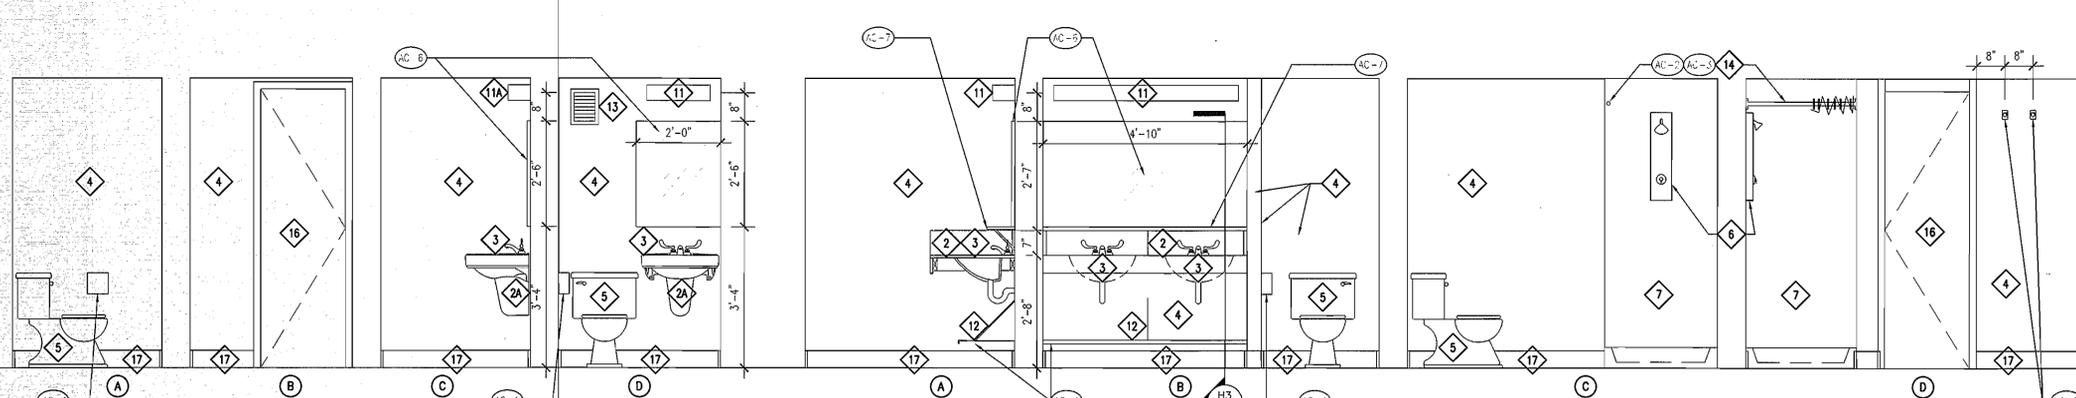
**B10** INTERIOR ELEVATION  
1/2"=1'-0"

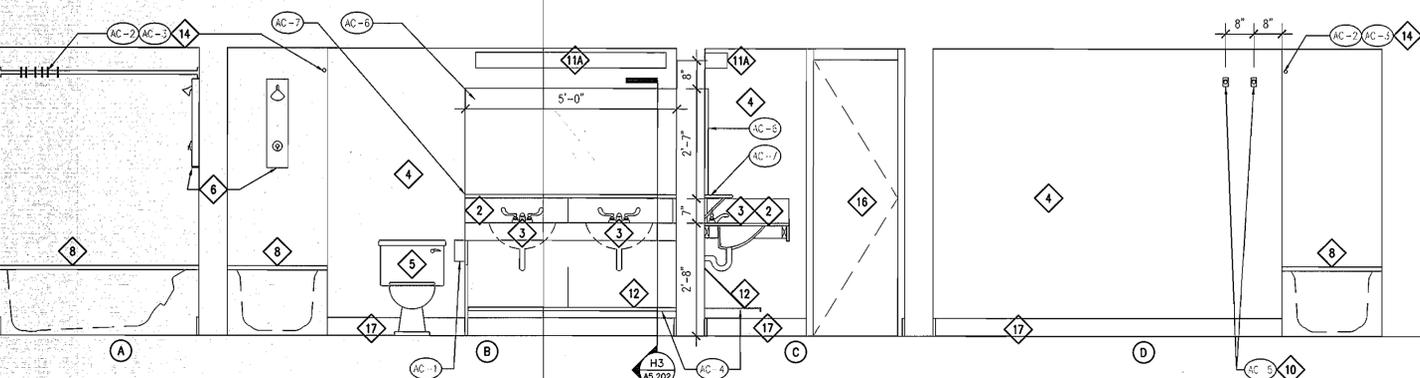

**C10** INTERIOR ELEVATION  
1/2"=1'-0"

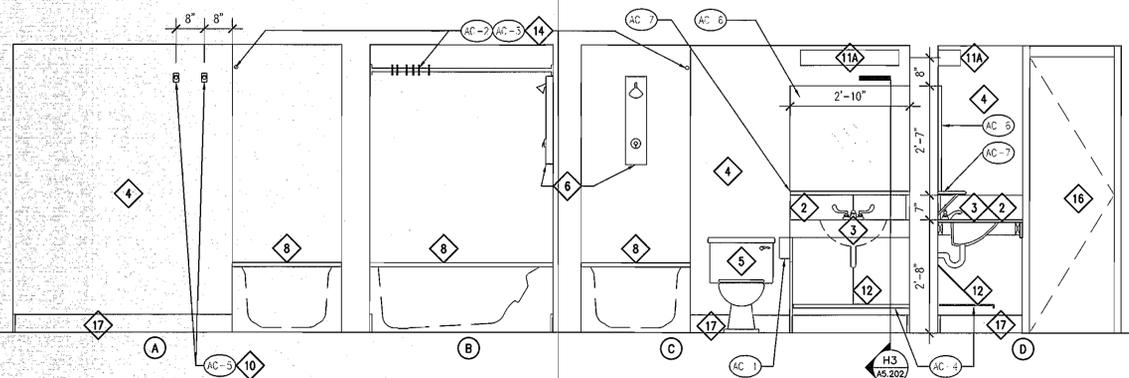

**D10** INTERIOR ELEVATION  
1/2"=1'-0"

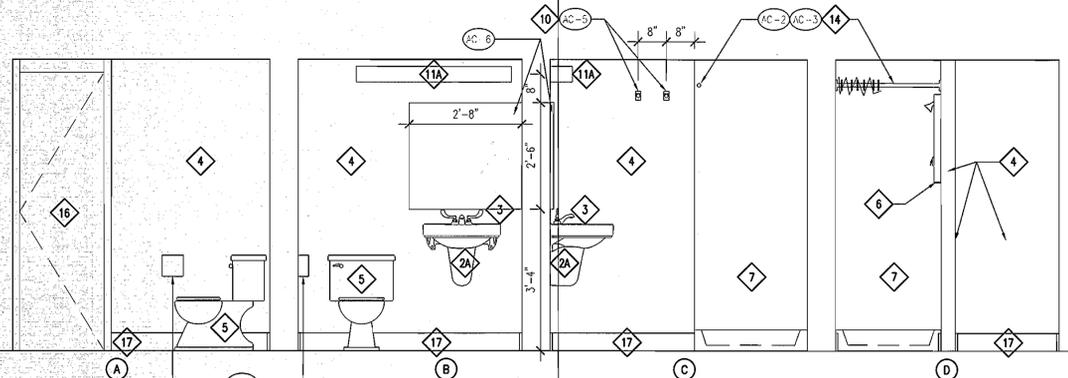

**F10** INTERIOR ELEVATION  
1/2"=1'-0"

**H7** INTERIOR ELEVATION  
1/2"=1'-0"

**H10** INTERIOR ELEVATION  
1/2"=1'-0"

**CONSTRUCTION NOTES**

- 1 PREPARE SUBFLOOR AND INSTALL NEW 2X2 CERAMIC TILE FLOORING & COVE.
- 2 INSTALL NEW SOLID SURFACE COUNTER, BACK SPLASH, SIDE SPLASH AND INTEGRAL SINKS. CONNECT TO EXISTING SUPPLY AND DRAIN.
- 2A INSTALL NEW WALL MOUNTED SINK CONNECT TO EXISTING SUPPLY AND DRAIN.
- 3 INSTALL NEW FAUCETS AND VALVES.
- 4 INSTALL FIBER REINFORCED PANELS FLOOR TO CEILING ON ALL BATHROOM WALLS (EXCEPT SHOWER & BATHTUB STALLS - REFER TO DETAIL B10/A2.201).
- 5 INSTALL NEW TOILET AND RECONNECT TO SUPPLY AND DRAIN.
- 6 INSTALL NEW BATHTUB DRAIN, VALVE AND SHOWERHEAD. (WORK TO BE PERFORMED BY BATHTUBTERS).
- 7 INSTALL NEW BATHTUBTERS SHOWER ENCLOSURES INCLUDING SHOWER PAN, WALL INSERTS & CEILING. (WORK TO BE PERFORMED BY BATHTUBTERS).
- 8 INSTALL NEW BATHTUBTERS BATHTUB LINER & WALL INSERTS. (WORK TO BE PERFORMED BY BATHTUBTERS).
- 9 INSTALL NEW DRAIN. (WORK TO BE PERFORMED BY BATHTUBTERS).
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- 11 PROVIDE AND INSTALL ONE WALL MOUNTED UP/DOWN FLUORESCENT LIGHT FIXTURE ABOVE SINK AND ONE CEILING MOUNTED LIGHT FIXTURE IN FRONT OF SHOWER (SEE REFLECTED CEILING PLAN). INSTALLATION INCLUDES WIREMOLD, WIRE AND SWITCH.
- 11A PROVIDE AND INSTALL ONE WALL MOUNTED UP/DOWN FLUORESCENT LIGHT FIXTURE ABOVE SINK (SEE REFLECTED CEILING PLAN). INSTALLATION INCLUDES WIREMOLD, WIRE AND SWITCH.
- 12 FURNISH AND INSTALL ONE 16" DEEP HEAVY DUTY, PLASTIC COATED METAL WIRE SHELF SET 8" A.F.F.
- 13 REINSTALL EXHAUST GRELLE IN CEILING.
- 14 INSTALL NEW SHOWER ROD AND CURTAIN AT EXISTING HEIGHT.
- 15 INSTALL ACCESS PANELS. REPLACE DAMAGED UNITS. (CONTINGENCY ALLOWANCE)
- 16 INSTALL NEW DOOR AND TRANSOM AS PER SCHEDULE. PATCH AND REPAIR EXISTING DOOR FRAME AND PAINT.
- 17 5" TILE COVE BASE ON ALL WALLS.
- 18 REINSTALL HEATER CABINET COVERS AND ENDS - APPLIES TO BATHROOM D1000 AND ALL FOURTH FLOOR BATHROOMS.

**TOILET ACCESSORIES**

- AC-1 TOILET PAPER HOLDER. TO BE PROVIDED BY OWNER AND INSTALLED BY CONTRACTOR.
- AC-2 STAINLESS STEEL, SATIN FINISH SHOWER ROD & MOUNTING BRACKETS.
- AC-3 SHOWER CURTAIN AND SHOWER CURTAIN RINGS.
- AC-4 NEW HEAVY DUTY METAL WIRE SHELF - MOUNTED 8" A.F.F.
- AC-5 NEW STAINLESS STEEL ROBE HOOKS MID. 6'-0" A.F.F.
- AC-6 NEW FRAMELESS MIRROR - REFER TO INTERIOR ELEVATIONS - AS.201/AS.202 FOR SIZING.
- AC-7 8" DEEP SOLID SURFACE PLASTIC SHELF.

**NOTE:**

1. BATHTUBTERS INSTALLATION TO BE DONE LAST.




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Project  
University of Rhode Island  
DORR HALL  
BATHROOM RENOVATIONS &  
DOOR & SIGNAGE REPLACEMENT  
KINGSTON, RI



Issues

Date	Description
12/20/2012	FOR CONSTRUCTION

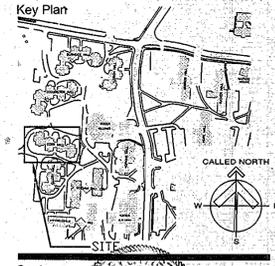Revisions

No.	Date	Description
1	12/05/2012	REVIEW

Drawing Title  
**FIRST FLOOR  
BATHROOM  
INTERIOR  
ELEVATIONS**

Issue Date: 12/20/2012


Project No: KC-R.ROGW.2010.001 Scale: AS NOTED

Project Manager: MT Production Leader: MS

Project Architect: MT Peer Reviewer: JM

Drawing Number

**A5.201**

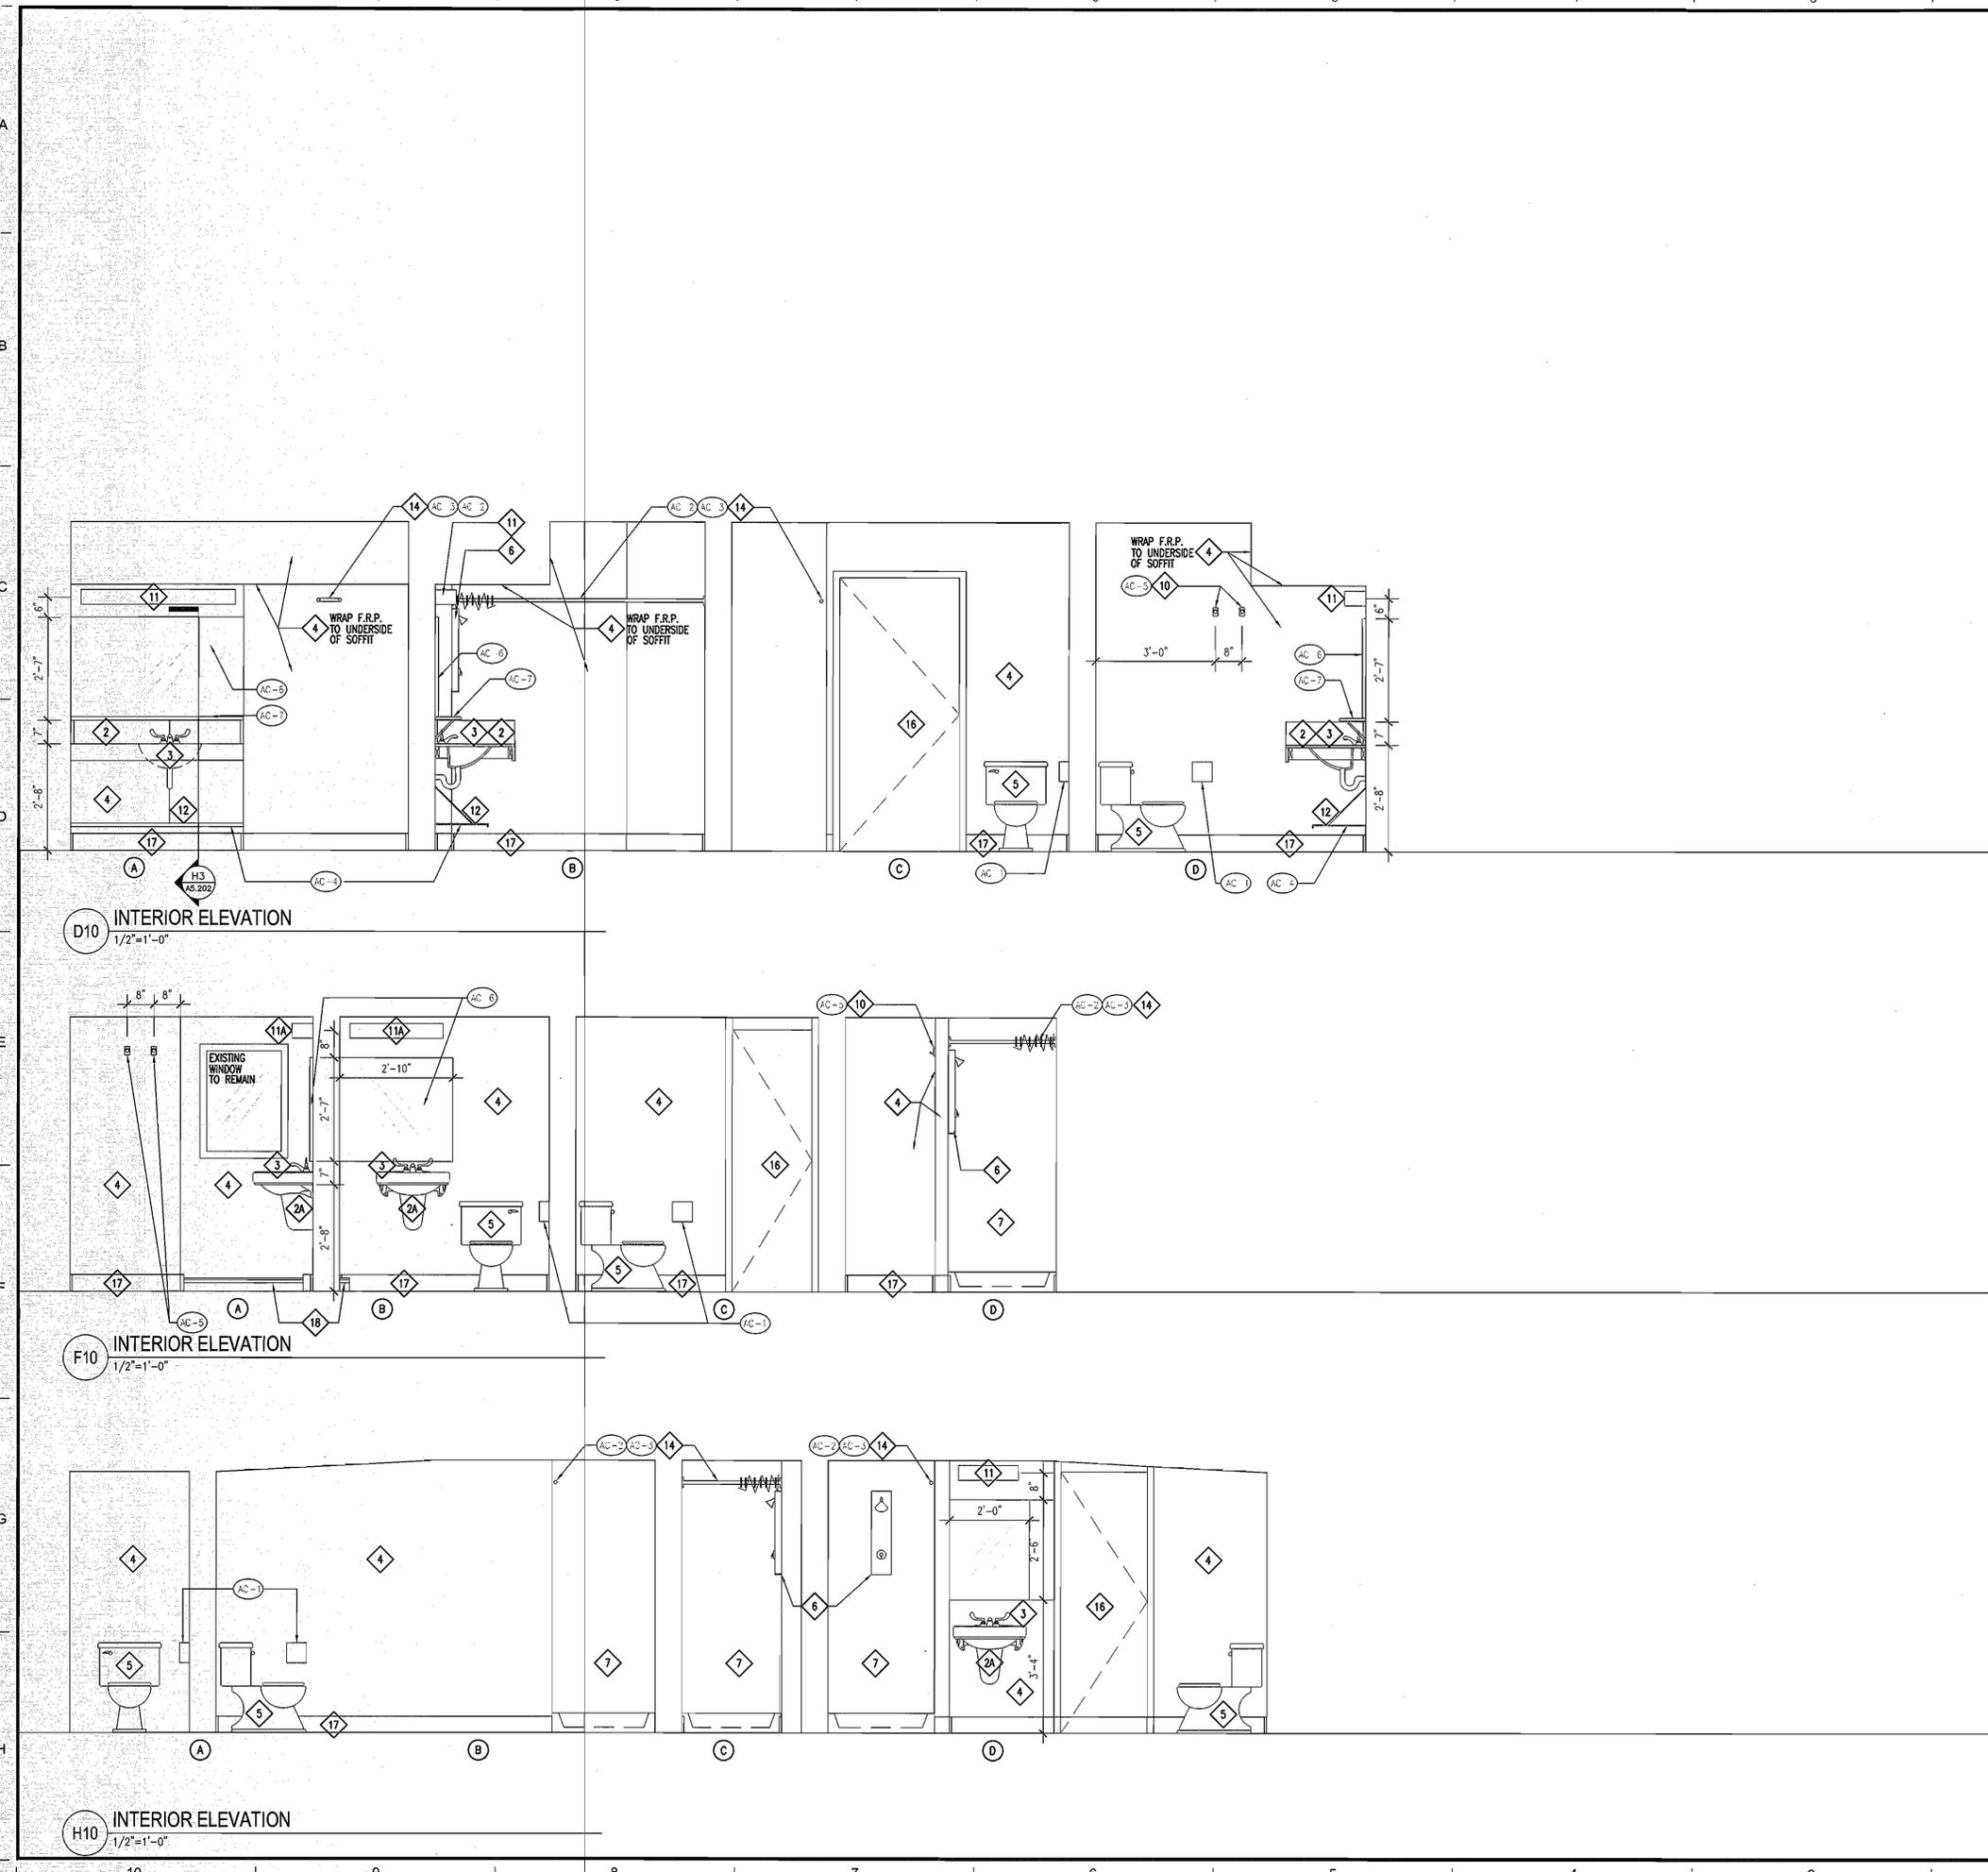

**CONSTRUCTION NOTES**

- 1 PREPARE SUBFLOOR AND INSTALL NEW 2X2 CERAMIC TILE FLOORING & COVE.
- 2 INSTALL NEW SOLID SURFACE COUNTER, BACK SPLASH, SIDE SPLASH AND INTEGRAL SINKS. CONNECT TO EXISTING SUPPLY AND DRAIN.
- 2A INSTALL NEW WALL MOUNTED SINK CONNECT TO EXISTING SUPPLY AND DRAIN.
- 3 INSTALL NEW FAUCETS AND VALVES.
- 4 INSTALL FIBER REINFORCED PANELS FLOOR TO CEILING ON ALL BATHROOM WALLS (EXCEPT SHOWER & BATHTUB STALLS - REFER TO DETAIL B10/A2.201).
- 5 INSTALL NEW TOILET AND RECONNECT TO SUPPLY AND DRAIN.
- 6 INSTALL NEW BATHTUBS DRAIN, VALVE AND SHOWERHEAD. (WORK TO BE PERFORMED BY BATHTUBBERS).
- 7 INSTALL NEW BATHTUBBERS SHOWER ENCLOSURES INCLUDING SHOWER PAN, WALL INSERTS & CEILING. (WORK TO BE PERFORMED BY BATHTUBBERS)
- 8 INSTALL NEW BATHTUBBERS BATHTUB LINER & WALL INSERTS. (WORK TO BE PERFORMED BY BATHTUBBERS)
- 9 INSTALL NEW DRAIN. (WORK TO BE PERFORMED BY BATHTUBBERS)
- 10 INSTALL NEW STAINLESS STEEL ROBE HOOKS @ 6'-0" AFF. REFER TO INTERIOR ELEVATIONS - A5.201/A5.202 FOR LOCATIONS
- 11 PROVIDE AND INSTALL ONE WALL MOUNTED UP/DOWN FLUORESCENT LIGHT FIXTURE ABOVE SINK AND ONE CEILING MOUNTED LIGHT FIXTURE IN FRONT OF SHOWER (SEE REFLECTED CEILING PLAN). INSTALLATION INCLUDES WIREKID, WIRE AND SWITCH.
- 11A PROVIDE AND INSTALL ONE WALL MOUNTED UP/DOWN FLUORESCENT LIGHT FIXTURE ABOVE SINK (SEE REFLECTED CEILING PLAN). INSTALLATION INCLUDES WIREKID, WIRE AND SWITCH.
- 12 FURNISH AND INSTALL ONE 16" DEEP HEAVY DUTY, PLASTIC COATED METAL WIRE SHELF SET 8" A.F.F.
- 13 REINSTALL EXHAUST GRILLE IN CEILING.
- 14 INSTALL NEW SHOWER ROD AND CURTAIN AT EXISTING HEIGHT.
- 15 INSTALL ACCESS PANELS. REPLACE DAMAGED UNITS. (CONTINGENCY ALLOWANCE)
- 16 INSTALL NEW DOOR AND TRANSOM AS PER SCHEDULE. PATCH AND REPAIR EXISTING DOOR FRAME AND PAINT.
- 17 5" TILE COVE BASE ON ALL WALLS.
- 18 REINSTALL HEATER CABINET COVERS AND ENDS - APPLIES TO BATHROOM D1000 AND ALL FOURTH FLOOR BATHROOMS.

**TOILET ACCESSORIES**

- AC-1 TOILET PAPER HOLDER. TO BE PROVIDED BY OWNER AND INSTALLED BY CONTRACTOR.
- AC-2 STAINLESS STEEL SATIN FINISH SHOWER ROD & MOUNTING BRACKETS.
- AC-3 SHOWER CURTAIN AND SHOWER CURTAIN RINGS
- AC-4 NEW HEAVY DUTY METAL WIRE SHELF - MOUNTED 8" A.F.F.
- AC-5 NEW STAINLESS STEEL ROBE HOOKS MTD. 6'-0" A.F.F.
- AC-6 NEW FRAMELESS MIRROR - REFER TO INTERIOR ELEVATIONS - A5.201/5.202 FOR SIZING.
- AC-7 8" DEEP SOLID SURFACE PLASTIC SHELF.

**NOTE:**

1. BATHTUBBERS INSTALLATION TO BE DONE LAST.




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 KINGSTON, RI

Project  
 University of Rhode Island  
 DORR HALL  
 BATHROOM RENOVATIONS &  
 DOOR & SIGNAGE REPLACEMENT  
 KINGSTON, RI



Issues

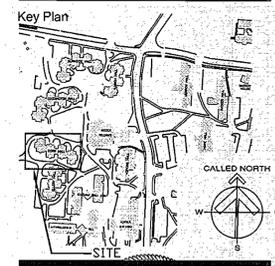Date	Description
12/20/2012	FOR CONSTRUCTION

Revisions

No.	Date	Description
1	12/05/2012	REVIEW

Drawing Title  
**FIRST FLOOR  
 BATHROOM  
 INTERIOR  
 ELEVATIONS CONT.**

Issue Date: 12/20/2012



Project No: KC-R-ROGW-2010.001 Scale: AS NOTED

Project Manager: MT Production Leader: MS

Project Architect: MT Peer Reviewer: JM

Drawing Number

**A5.202**

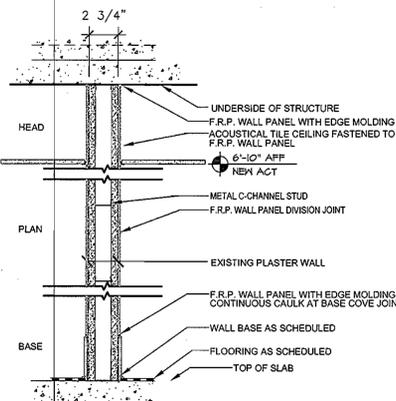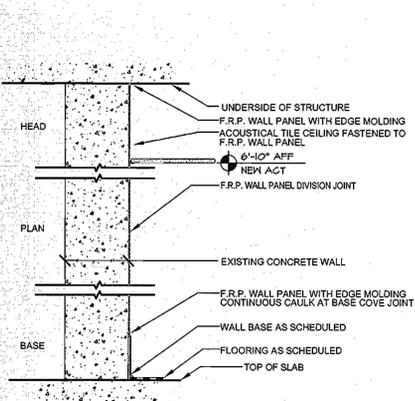

**FINISH LEGEND**

- 2x2 MOSAIC FLOOR TILE - REFER TO SPECIFICATION
- CT-1 5" CERAMIC WALL TILE COVE BASE - REFER TO SPECIFICATION
- F.R.P. WALL COVERING - F.R.P. WALL PANEL ADHERED TO EXISTING WALL SURFACE TO BE INSTALLED ON ALL WALL SURFACE EXCEPT FOR WHERE BATHTITERS TUB AND SHOWER ENCLOSURES ARE TO BE INSTALLED. - REFER TO SPECIFICATION & SEE ALSO DETAIL B10 /A5.201.
- ACT FIBERGLASS ACOUSTICAL TILE CEILING - REFER TO SPECIFICATION.
- SS-1 COUNTER TOP MATERIAL TO BE SOLID SURFACE - REFER TO SPECIFICATION.
- PF-1 BONDO PATCH ANY DAMAGE TO EXISTING BATHROOM DOOR FRAMES, SAND SMOOTH AND PAINT - REFER TO SPECIFICATION.
- FLOOR DRAIN. SEE "D" DRAWINGS.

**GENERAL FINISH NOTES**

- FINISH PLAN IS FOR REFERENCE & TO BE APPLICABLE AT ALL BATHROOMS.
- COORDINATE ALL FINISHES WITH SPECIFICATIONS.

**CONSTRUCTION NOTES**

- PREPARE SUBFLOOR AND INSTALL NEW 2x2 CERAMIC TILE FLOORING & COVE.
- INSTALL NEW SOLID SURFACE COUNTER, BACK SPLASH, SIDE SPLASH AND INTEGRAL SINKS. CONNECT TO EXISTING SUPPLY AND DRAIN.
- INSTALL NEW WALL MOUNTED SINK CONNECT TO EXISTING SUPPLY AND DRAIN.
- INSTALL NEW FAUCETS AND VALVES.
- INSTALL FIBER REINFORCED PANELS FLOOR TO CEILING ON ALL BATHROOM WALLS (EXCEPT SHOWER & BATHTUB STALLS - REFER TO DETAIL B10/A5.201).
- INSTALL NEW TOILET AND RECONNECT TO SUPPLY AND DRAIN.
- INSTALL NEW BATHTITERS DRAIN, VALVE AND SHOWERHEAD. (WORK TO BE PERFORMED BY BATHTITERS).
- INSTALL NEW BATHTITERS SHOWER ENCLOSURES INCLUDING SHOWER PAN, WALL INSERTS & CEILING. (WORK TO BE PERFORMED BY BATHTITERS).
- INSTALL NEW BATHTITERS BATHTUB LINER & WALL INSERTS. (WORK TO BE PERFORMED BY BATHTITERS).
- INSTALL NEW DRAIN. (WORK TO BE PERFORMED BY BATHTITERS).
- INSTALL NEW STAINLESS STEEL ROSE HOOKS 6"-0" AFF. REFER TO INTERIOR ELEVATIONS - A5.201/A5.202 FOR LOCATIONS.
- PROVIDE AND INSTALL ONE WALL MOUNTED UP/DOWN FLUORESCENT LIGHT FIXTURE ABOVE SINK AND ONE CEILING MOUNTED LIGHT FIXTURE IN FRONT OF SHOWER (SEE REFLECTED CEILING PLAN). INSTALLATION INCLUDES WIREMOLD, WIRE AND SWITCHES.
- PROVIDE AND INSTALL ONE WALL MOUNTED UP/DOWN FLUORESCENT LIGHT FIXTURE ABOVE SINK (SEE REFLECTED CEILING PLAN). INSTALLATION INCLUDES WIREMOLD, WIRE AND SWITCHES.
- FURNISH AND INSTALL ONE 16" DEEP HEAVY DUTY, PLASTIC COATED METAL WIRE SHELF SET 8" A.F.F.
- REINSTALL EXHAUST GRILLE IN CEILING.
- INSTALL NEW SHOWER ROD AND CURTAIN AT EXISTING HEIGHT.
- INSTALL ACCESS PANELS. REPLACE DAMAGED UNITS. (CONTINGENCY ALLOWANCE)
- INSTALL NEW DOOR AND TRANSOM AS PER SCHEDULE. PATCH AND REPAIR EXISTING DOOR FRAME AND PAINT.
- 5" TILE COVE BASE ON ALL WALLS.
- REINSTALL HEATER CABINET COVERS AND ENDS - APPLIES TO BATHROOM D1006 AND ALL FOURTH FLOOR BATHROOMS.


**TOILET ACCESSORIES**

- AC-1 TOILET PAPER HOLDER. TO BE PROVIDED BY OWNER AND INSTALLED BY CONTRACTOR.
- AC-2 STAINLESS STEEL SATIN FINISH SHOWER ROD & MOUNTING BRACKETS.
- AC-3 SHOWER CURTAIN AND SHOWER CURTAIN RINGS
- AC-4 NEW HEAVY DUTY METAL WIRE SHELF - MOUNTED 8" A.F.F.
- AC-5 NEW STAINLESS STEEL ROSE HOOKS MTD. 6"-0" A.F.F.
- AC-6 NEW FRAMELESS MIRROR - REFER TO INTERIOR ELEVATIONS - A5.201/A5.202 FOR SIZES.
- AC-7 8" DEEP SOLID SURFACE PLASTIC SHELF.


**NOTE:**

- BATHTITERS INSTALLATION TO BE DONE LAST.


**WALL TYPES**

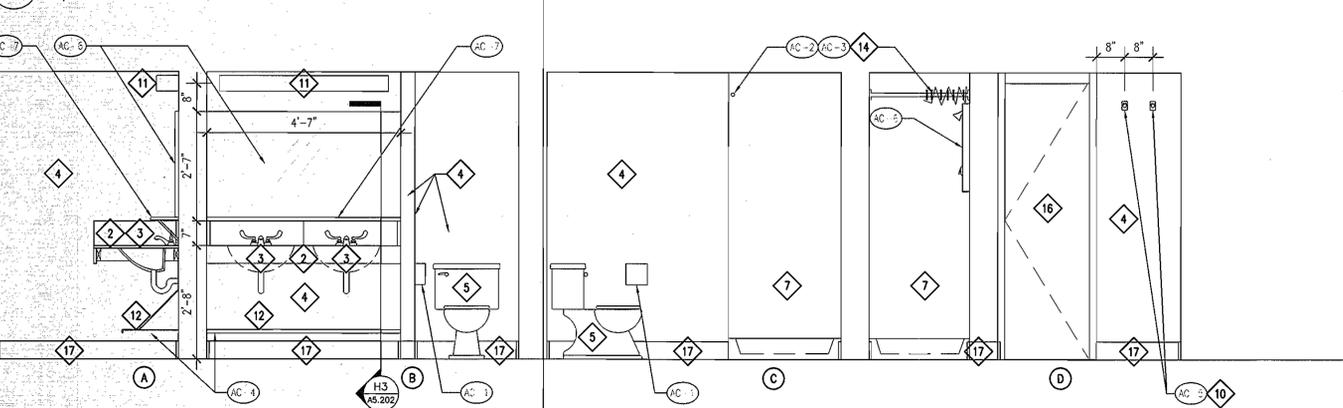


**INTERIOR ELEVATION - SECOND THIRD & FOURTH FLOORS**

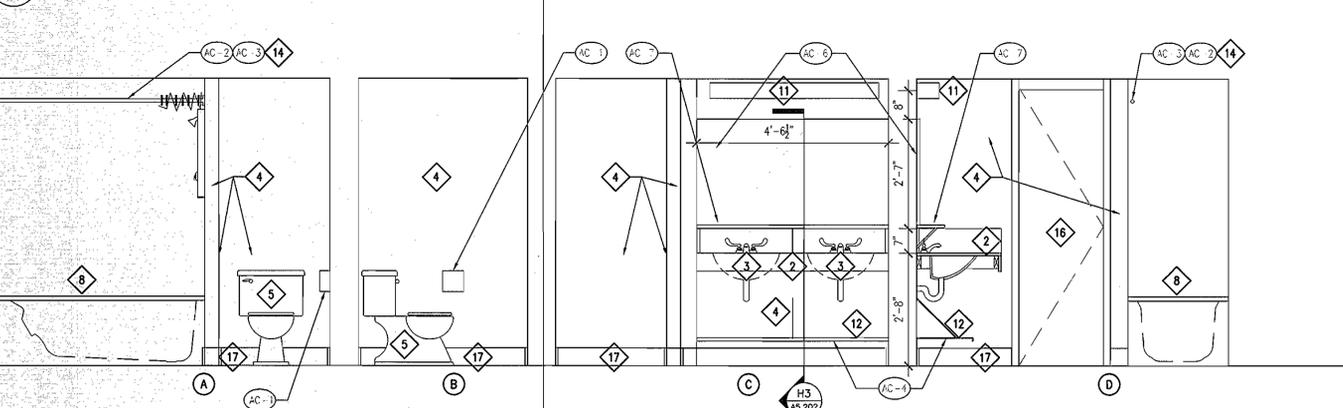


**INTERIOR ELEVATION - SECOND THIRD & FOURTH FLOORS**

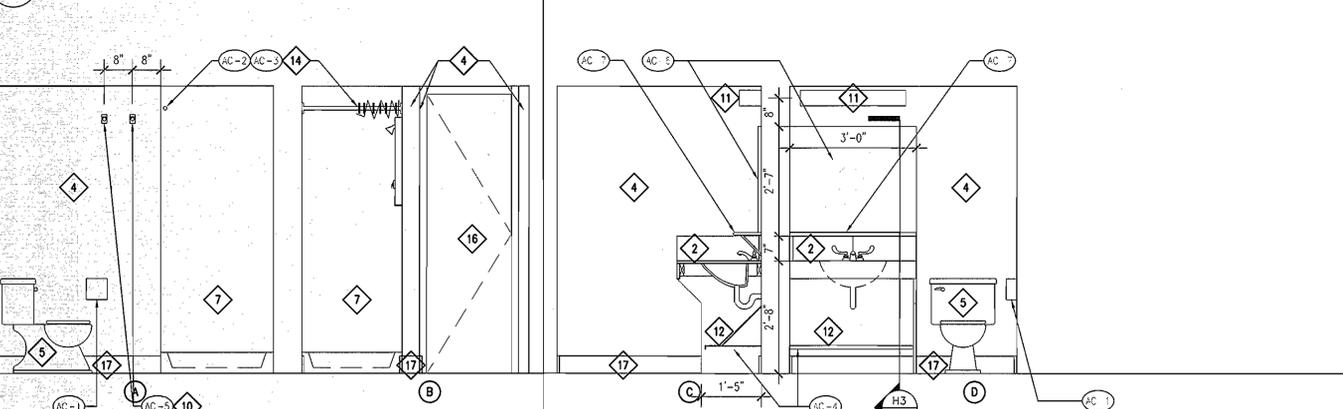

**INTERIOR ELEVATION - SECOND THIRD & FOURTH FLOORS**

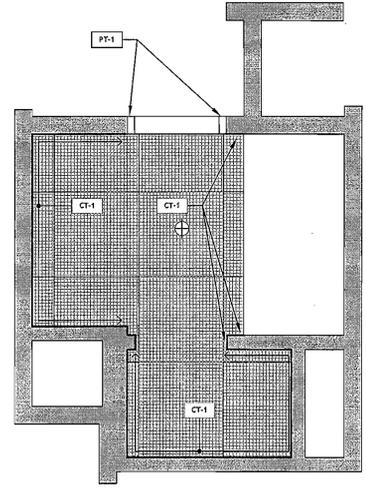

**TYPICAL FINISH FLOOR PLAN**

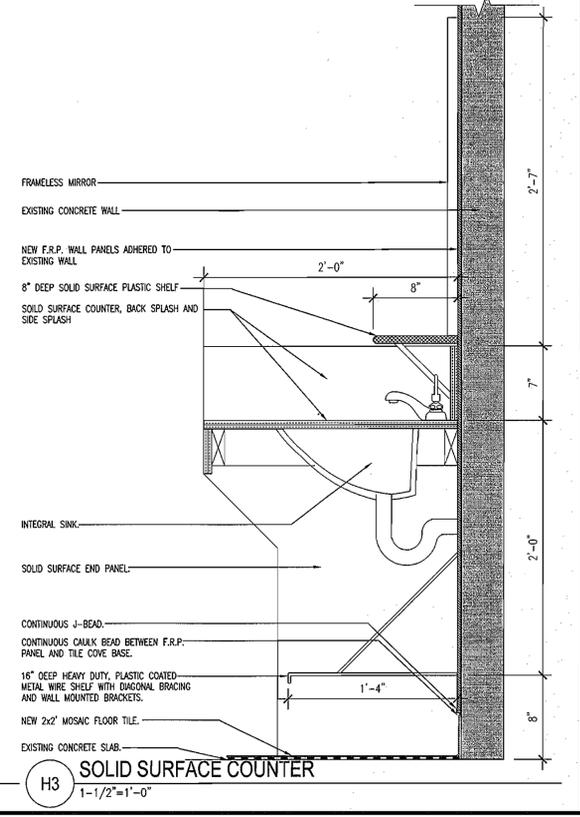


**SOLID SURFACE COUNTER**

**TectonArchitects inc**  
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 860 548 0802  
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Project  
 University of Rhode Island  
 DORR HALL  
 BATHROOM RENOVATIONS &  
 DOOR & SIGNAGE REPLACEMENT  
 KINGSTON, RI



Seals  
 REGISTERED ARCHITECT

**Issues**

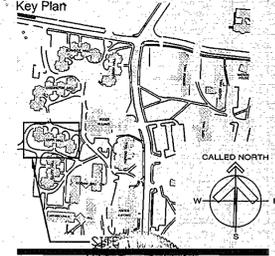Date	Description
12/20/2012	FOR CONSTRUCTION

**Revisions**

No.	Date	Description
1	12/05/2012	REVIEW

**Drawing Title**  
 UPPER FLOOR  
 BATHROOM  
 INTERIOR  
 ELEVATIONS

**Issue Date:** 12/20/2012  
**Project No:** KC-R-ROGIV-2010-001 **Scale:** AS NOTED  
**Project Manager:** MT **Production Leader:** MS  
**Project Architect:** MT **Peer Reviewer:** JM  
**Drawing Number**

**A5.203**





**THIRD FLOOR DOOR, FRAME & SIGNAGE SCHEDULE**

NOTE: PRIOR TO ORDERING OF ANY UNITS ALL DIMENSIONS SHALL BE FIELD VERIFIED


ALTERNATE	NUMBER	SIZE	DOOR				FRAME			TRANSOM	DOOR RATING	HDWR.	SIGN		TRANSOM HT. (TOP OF DOOR TO TOP OF FRAME) REMARKS
			ELEV.	MTL.	THK.	FINISH	MT.	THK.	FINISH				ELEV.	TYPE	
	A300A	2'-4" x 7'-5 1/2"	A	WD.	1-3/4"	TRANS.	EXIST.	EXIST.	EXIST.	A	20 MIN	1	C3/F8	A300A	
	A300B	2'-4" x 7'-5 1/2"	A	WD.	1-3/4"	TRANS.	EXIST.	EXIST.	EXIST.	A	20 MIN	1	C3/F8	A300B	
	A300C	2'-4" x 7'-5 1/2"	A	WD.	1-3/4"	TRANS.	EXIST.	EXIST.	EXIST.	A	20 MIN	1	C3/F8	A300C	
	A300D	2'-4" x 7'-5 1/2"	A	WD.	1-3/4"	TRANS.	EXIST.	EXIST.	EXIST.	A	20 MIN	1	C3/F8	A300D	
	A300E	2'-0" x 6'-8"	B	WD.	1-3/4"	TRANS.	EXIST.	EXIST.	EXIST.	A	20 MIN	2	C10		9 1/2"
	A300F	2'-0" x 6'-8"	B	WD.	1-3/4"	TRANS.	EXIST.	EXIST.	EXIST.	A	20 MIN	2	C10		9 1/2"
	A301A	2'-4" x 7'-5 1/2"	A	WD.	1-3/4"	TRANS.	EXIST.	EXIST.	EXIST.	A	20 MIN	1	C3/F8	A301A	
	A301B	2'-4" x 7'-5 1/2"	A	WD.	1-3/4"	TRANS.	EXIST.	EXIST.	EXIST.	A	20 MIN	1	C3/F8	A301B	
	A301C	2'-4" x 7'-5 1/2"	A	WD.	1-3/4"	TRANS.	EXIST.	EXIST.	EXIST.	A	20 MIN	1	C3/F8	A301C	
	A301D	2'-4" x 7'-5 1/2"	A	WD.	1-3/4"	TRANS.	EXIST.	EXIST.	EXIST.	A	20 MIN	1	C3/F8	A301D	
	A301E	2'-0" x 6'-8"	B	WD.	1-3/4"	TRANS.	EXIST.	EXIST.	EXIST.	A	20 MIN	2	C10		9 1/2"
	A301F	2'-0" x 6'-8"	B	WD.	1-3/4"	TRANS.	EXIST.	EXIST.	EXIST.	A	20 MIN	2	C10		9 1/2"
	A302A	2'-0" x 6'-8"	B	WD.	1-3/4"	TRANS.	EXIST.	EXIST.	EXIST.	A	20 MIN	3	C7	A302A	9 1/2"
	A302B	2'-0" x 6'-8"	B	WD.	1-3/4"	TRANS.	EXIST.	EXIST.	EXIST.	A	20 MIN	3	C7	A302B	9 1/2"
	A302C	EXISTING TO REMAIN	EXIST.	EXIST.	EXIST.	H3/F8/C9		DOORS TO STAIRS PREVIOUSLY REPLACED							
	A302D	EXISTING TO REMAIN	EXIST.	EXIST.	EXIST.	H3/F8/C9		DOORS TO STAIRS PREVIOUSLY REPLACED							
	B300A	2'-4" x 7'-5 1/2"	A	WD.	1-3/4"	TRANS.	EXIST.	EXIST.	EXIST.	A	20 MIN	1	C3/F8	B300A	
	B300B	2'-4" x 7'-5 1/2"	A	WD.	1-3/4"	TRANS.	EXIST.	EXIST.	EXIST.	A	20 MIN	1	C3/F8	B300B	
	B300C	2'-4" x 7'-5 1/2"	A	WD.	1-3/4"	TRANS.	EXIST.	EXIST.	EXIST.	A	20 MIN	1	C3/F8	B300C	
	B300D	2'-4" x 7'-5 1/2"	A	WD.	1-3/4"	TRANS.	EXIST.	EXIST.	EXIST.	A	20 MIN	1	C3/F8	B300D	
	B300E	2'-0" x 6'-8"	B	WD.	1-3/4"	TRANS.	EXIST.	EXIST.	EXIST.	A	20 MIN	2	C10		9 1/2"
	B300F	2'-0" x 6'-8"	B	WD.	1-3/4"	TRANS.	EXIST.	EXIST.	EXIST.	A	20 MIN	2	C10		9 1/2"
	B301A	2'-4" x 7'-5 1/2"	A	WD.	1-3/4"	TRANS.	EXIST.	EXIST.	EXIST.	A	20 MIN	1	C3/F8	B301A	
	B301B	2'-4" x 7'-5 1/2"	A	WD.	1-3/4"	TRANS.	EXIST.	EXIST.	EXIST.	A	20 MIN	1	C3/F8	B301B	
	B301C	2'-4" x 7'-5 1/2"	A	WD.	1-3/4"	TRANS.	EXIST.	EXIST.	EXIST.	A	20 MIN	1	C3/F8	B301C	
	B301D	2'-4" x 7'-5 1/2"	A	WD.	1-3/4"	TRANS.	EXIST.	EXIST.	EXIST.	A	20 MIN	1	C3/F8	B301D	
	B301E	2'-4" x 7'-5 1/2"	A	WD.	1-3/4"	TRANS.	EXIST.	EXIST.	EXIST.	A	20 MIN	1	C3/F8	B301E	
	B300F	2'-0" x 6'-8"	B	WD.	1-3/4"	TRANS.	EXIST.	EXIST.	EXIST.	A	20 MIN	2	C10		9 1/2"
	B300G	2'-0" x 6'-8"	B	WD.	1-3/4"	TRANS.	EXIST.	EXIST.	EXIST.	A	20 MIN	2	C10		9 1/2"
	B302A	2'-0" x 6'-8"	B	WD.	1-3/4"	TRANS.	EXIST.	EXIST.	EXIST.	A	20 MIN	3	C7	B302A	9 1/2"
	B302B	2'-0" x 6'-8"	B	WD.	1-3/4"	TRANS.	EXIST.	EXIST.	EXIST.	A	20 MIN	3	C7	B302B	9 1/2"
	B302C	EXISTING TO REMAIN	EXIST.	EXIST.	EXIST.	H3/F8/C9		DOORS TO STAIRS PREVIOUSLY REPLACED							
	B302D	EXISTING TO REMAIN	EXIST.	EXIST.	EXIST.	H3/F8/C9		DOORS TO STAIRS PREVIOUSLY REPLACED							
	C300A	2'-4" x 7'-5 1/2"	A	WD.	1-3/4"	TRANS.	EXIST.	EXIST.	EXIST.	A	20 MIN	1	C3/F8	C300A	
	C300B	2'-4" x 7'-5 1/2"	A	WD.	1-3/4"	TRANS.	EXIST.	EXIST.	EXIST.	A	20 MIN	1	C3/F8	C300B	
	C300C	2'-4" x 7'-5 1/2"	A	WD.	1-3/4"	TRANS.	EXIST.	EXIST.	EXIST.	A	20 MIN	1	C3/F8	C300C	
	C300D	2'-4" x 7'-5 1/2"	A	WD.	1-3/4"	TRANS.	EXIST.	EXIST.	EXIST.	A	20 MIN	1	C3/F8	C300D	
	C300E	2'-0" x 6'-8"	B	WD.	1-3/4"	TRANS.	EXIST.	EXIST.	EXIST.	A	20 MIN	2	C10		9 1/2"
	C300F	2'-0" x 6'-8"	B	WD.	1-3/4"	TRANS.	EXIST.	EXIST.	EXIST.	A	20 MIN	2	C10		9 1/2"
	C301A	2'-4" x 7'-5 1/2"	A	WD.	1-3/4"	TRANS.	EXIST.	EXIST.	EXIST.	A	20 MIN	1	C3/F8	C301A	
	C301B	2'-4" x 7'-5 1/2"	A	WD.	1-3/4"	TRANS.	EXIST.	EXIST.	EXIST.	A	20 MIN	1	C3/F8	C301B	
	C301C	2'-4" x 7'-5 1/2"	A	WD.	1-3/4"	TRANS.	EXIST.	EXIST.	EXIST.	A	20 MIN	1	C3/F8	C301C	
	C301D	2'-4" x 7'-5 1/2"	A	WD.	1-3/4"	TRANS.	EXIST.	EXIST.	EXIST.	A	20 MIN	1	C3/F8	C301D	
	C301E	2'-0" x 6'-8"	B	WD.	1-3/4"	TRANS.	EXIST.	EXIST.	EXIST.	A	20 MIN	2	C10		9 1/2"
	C301F	2'-0" x 6'-8"	B	WD.	1-3/4"	TRANS.	EXIST.	EXIST.	EXIST.	A	20 MIN	2	C10		9 1/2"
	C302A	2'-0" x 6'-8"	B	WD.	1-3/4"	TRANS.	EXIST.	EXIST.	EXIST.	A	20 MIN	3	C7	C302A	9 1/2"
	C302B	2'-0" x 6'-8"	B	WD.	1-3/4"	TRANS.	EXIST.	EXIST.	EXIST.	A	20 MIN	3	C7	C302B	9 1/2"
	C302C	EXISTING TO REMAIN	EXIST.	EXIST.	EXIST.	H3/F8/C9		DOORS TO STAIRS PREVIOUSLY REPLACED							
	C302D	EXISTING TO REMAIN	EXIST.	EXIST.	EXIST.	H3/F8/C9		DOORS TO STAIRS PREVIOUSLY REPLACED							
	D300A	2'-4" x 7'-5 1/2"	A	WD.	1-3/4"	TRANS.	EXIST.	EXIST.	EXIST.	A	20 MIN	1	C3/F8	D300A	
	D300B	2'-4" x 7'-5 1/2"	A	WD.	1-3/4"	TRANS.	EXIST.	EXIST.	EXIST.	A	20 MIN	1	C3/F8	D300B	
	D300C	2'-4" x 7'-5 1/2"	A	WD.	1-3/4"	TRANS.	EXIST.	EXIST.	EXIST.	A	20 MIN	1	C3/F8	D300C	
	D300D	2'-4" x 7'-5 1/2"	A	WD.	1-3/4"	TRANS.	EXIST.	EXIST.	EXIST.	A	20 MIN	1	C3/F8	D300D	
	D300E	2'-0" x 6'-8"	B	WD.	1-3/4"	TRANS.	EXIST.	EXIST.	EXIST.	A	20 MIN	2	C10		9 1/2"
	D300F	2'-0" x 6'-8"	B	WD.	1-3/4"	TRANS.	EXIST.	EXIST.	EXIST.	A	20 MIN	2	C10		9 1/2"
	D301A	2'-4" x 7'-5 1/2"	A	WD.	1-3/4"	TRANS.	EXIST.	EXIST.	EXIST.	A	20 MIN	1	C3/F8	D301A	
	D301B	2'-4" x 7'-5 1/2"	A	WD.	1-3/4"	TRANS.	EXIST.	EXIST.	EXIST.	A	20 MIN	1	C3/F8	D301B	
	D301C	2'-4" x 7'-5 1/2"	A	WD.	1-3/4"	TRANS.	EXIST.	EXIST.	EXIST.	A	20 MIN	1	C3/F8	D301C	
	D301D	2'-4" x 7'-5 1/2"	A	WD.	1-3/4"	TRANS.	EXIST.	EXIST.	EXIST.	A	20 MIN	1	C3/F8	D301D	
	D301E	2'-4" x 7'-5 1/2"	A	WD.	1-3/4"	TRANS.	EXIST.	EXIST.	EXIST.	A	20 MIN	1	C3/F8	D301E	
	D300F	2'-0" x 6'-8"	B	WD.	1-3/4"	TRANS.	EXIST.	EXIST.	EXIST.	A	20 MIN	2	C10		9 1/2"
	D300G	2'-0" x 6'-8"	B	WD.	1-3/4"	TRANS.	EXIST.	EXIST.	EXIST.	A	20 MIN	2	C10		9 1/2"
	D302A	2'-0" x 6'-8"	B	WD.	1-3/4"	TRANS.	EXIST.	EXIST.	EXIST.	A	20 MIN	3	C7	D302A	9 1/2"
	D302B	2'-0" x 6'-8"	B	WD.	1-3/4"	TRANS.	EXIST.	EXIST.	EXIST.	A	20 MIN	3	C7	D302B	9 1/2"
	D302C	EXISTING TO REMAIN	EXIST.	EXIST.	EXIST.	H3/F8/C9		DOORS TO STAIRS PREVIOUSLY REPLACED							
	D302D	EXISTING TO REMAIN	EXIST.	EXIST.	EXIST.	H3/F8/C9		DOORS TO STAIRS PREVIOUSLY REPLACED							

NOTE: ALL GREY BOXES SHALL INDICATE A DOOR THAT IS ASSOCIATED WITH ALTERNATE #2

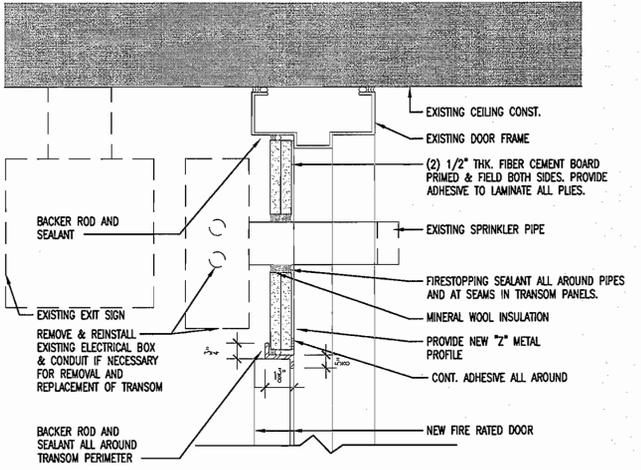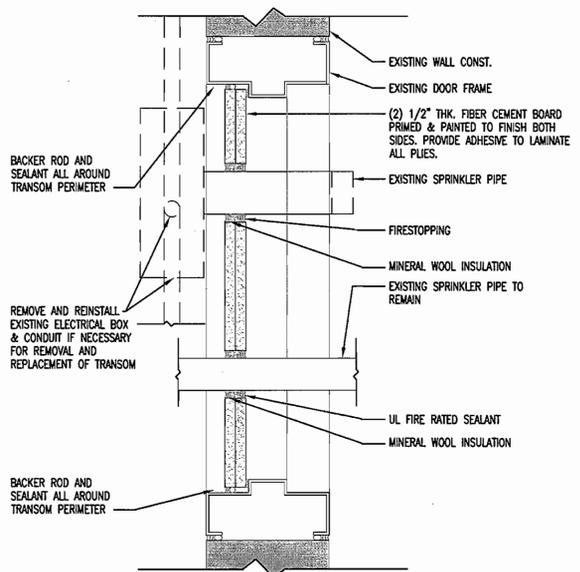


E5 TRANSOM HORIZONTAL SECTION  
3" = 1'-0" SIM. TO U.L. #(W-L-1016)

E5 TRANSOM VERTICAL SECTION  
3" = 1'-0" SIM. TO U.L. #(W-L-1016)

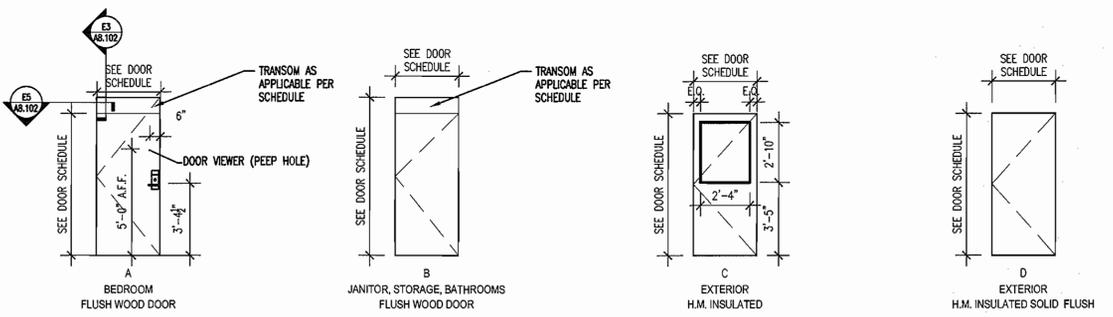

G5 DOOR ELEVATIONS  
N.T.S.

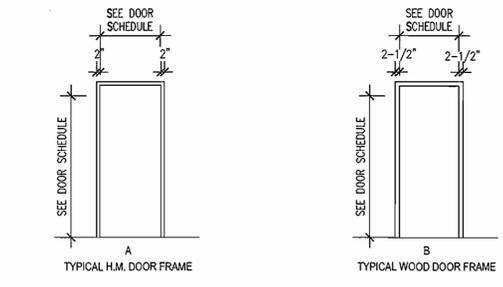

H5 FRAME ELEVATIONS  
N.T.S.

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Consultant  
  
 Gregory P. Fawcett  
 Consulting Engineer

Owner  
**THE UNIVERSITY OF RHODE ISLAND**

THINK BIG WE DO

Project  
**University of Rhode Island DORR HALL BATHROOM RENOVATIONS & DOOR & SIGNAGE REPLACEMENT KINGSTON, RI**



Seals

Issues

Date	Description
12/20/2012	FOR CONSTRUCTION

Revisions

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1	12/05/2012	REVIEW

Drawing Title

**SIGN & DOOR SCHEDULE & DETAILS**

Issue Date: 12/20/2012

Project No: KC-R-ROGIV-2010-001	Scale: AS NOTED
Project Manager: MT	Production Leader: MS
Project Architect: MT	Peer Reviewer: JM

Drawing Number

**A8.102**

**FOURTH FLOOR DOOR, FRAME & SIGNAGE SCHEDULE**

NOTE: PRIOR TO ORDERING OF ANY UNITS ALL DIMENSIONS SHALL BE FIELD VERIFIED

ALTERNATE	NUMBER	SIZE	DOOR				FRAME				TRANSOM	DOOR RATING	HDWR.	SIGN		TRANSOM HT. (TOP OF DOOR TO TOP OF FRAME)	REMARKS
			ELEV.	MTL.	THK.	FINISH	MT.	THK.	FINISH	ELEV.				TYPE	RM#		
	A400A	2'-4" x 7'-5 1/2"	A	WD.	1-3/4"	TRANS.	EXIST.	EXIST.	EXIST.	A		20 MIN	1	C3/F8	A400A		
	A400B	2'-4" x 7'-5 1/2"	A	WD.	1-3/4"	TRANS.	EXIST.	EXIST.	EXIST.	A		20 MIN	1	C3/F8	A400B		
	A400C	2'-4" x 7'-5 1/2"	A	WD.	1-3/4"	TRANS.	EXIST.	EXIST.	EXIST.	A		20 MIN	1	C3/F8	A400C		
	A400D	2'-4" x 7'-5 1/2"	A	WD.	1-3/4"	TRANS.	EXIST.	EXIST.	EXIST.	A		20 MIN	1	C3/F8	A400D		
	A400E	2'-0" x 6'-8"	B	WD.	1-3/4"	TRANS.	EXIST.	EXIST.	EXIST.	A		20 MIN	2	C10		9 1/2"	
	A400F	2'-0" x 6'-8"	B	WD.	1-3/4"	TRANS.	EXIST.	EXIST.	EXIST.	A		20 MIN	2	C10		9 1/2"	
	A401A	2'-4" x 7'-5 1/2"	A	WD.	1-3/4"	TRANS.	EXIST.	EXIST.	EXIST.	A		20 MIN	1	C3/F8	A401A		
	A401B	2'-4" x 7'-5 1/2"	A	WD.	1-3/4"	TRANS.	EXIST.	EXIST.	EXIST.	A		20 MIN	1	C3/F8	A401B		
	A401C	2'-4" x 7'-5 1/2"	A	WD.	1-3/4"	TRANS.	EXIST.	EXIST.	EXIST.	A		20 MIN	1	C3/F8	A401C		
	A401D	2'-4" x 7'-5 1/2"	A	WD.	1-3/4"	TRANS.	EXIST.	EXIST.	EXIST.	A		20 MIN	1	C3/F8	A401D		
	A401E	2'-0" x 6'-8"	B	WD.	1-3/4"	TRANS.	EXIST.	EXIST.	EXIST.	A		20 MIN	2	C10		9 1/2"	
	A401F	2'-0" x 6'-8"	B	WD.	1-3/4"	TRANS.	EXIST.	EXIST.	EXIST.	A		20 MIN	2	C10		9 1/2"	
	A402A	2'-0" x 6'-8"	B	WD.	1-3/4"	TRANS.	EXIST.	EXIST.	EXIST.	A		20 MIN	3	C7	A402A	9 1/2"	
	A402B	2'-0" x 6'-8"	B	WD.	1-3/4"	TRANS.	EXIST.	EXIST.	EXIST.	A		20 MIN	3	C7	A402B	9 1/2"	
	A402C	EXISTING TO REMAIN	EXIST.		EXIST.	EXIST.	H3/F8/C9		DOORS TO STAIRS PREVIOUSLY REPLACED								
	A402D	EXISTING TO REMAIN	EXIST.		EXIST.	EXIST.	H3/F8/C9		DOORS TO STAIRS PREVIOUSLY REPLACED								
	B400A	2'-4" x 7'-5 1/2"	A	WD.	1-3/4"	TRANS.	EXIST.	EXIST.	EXIST.	A		20 MIN	1	C3/F8	B400A		
	B400B	2'-4" x 7'-5 1/2"	A	WD.	1-3/4"	TRANS.	EXIST.	EXIST.	EXIST.	A		20 MIN	1	C3/F8	B400B		
	B400C	2'-4" x 7'-5 1/2"	A	WD.	1-3/4"	TRANS.	EXIST.	EXIST.	EXIST.	A		20 MIN	1	C3/F8	B400C		
	B400D	2'-4" x 7'-5 1/2"	A	WD.	1-3/4"	TRANS.	EXIST.	EXIST.	EXIST.	A		20 MIN	1	C3/F8	B400D		
	B400E	2'-0" x 6'-8"	B	WD.	1-3/4"	TRANS.	EXIST.	EXIST.	EXIST.	A		20 MIN	2	C10		9 1/2"	
	B400F	2'-0" x 6'-8"	B	WD.	1-3/4"	TRANS.	EXIST.	EXIST.	EXIST.	A		20 MIN	2	C10		9 1/2"	
	B401A	2'-4" x 7'-5 1/2"	A	WD.	1-3/4"	TRANS.	EXIST.	EXIST.	EXIST.	A		20 MIN	1	C3/F8	B401A		
	B401B	2'-4" x 7'-5 1/2"	A	WD.	1-3/4"	TRANS.	EXIST.	EXIST.	EXIST.	A		20 MIN	1	C3/F8	B401B		
	B401C	2'-4" x 7'-5 1/2"	A	WD.	1-3/4"	TRANS.	EXIST.	EXIST.	EXIST.	A		20 MIN	1	C3/F8	B401C		
	B401D	2'-4" x 7'-5 1/2"	A	WD.	1-3/4"	TRANS.	EXIST.	EXIST.	EXIST.	A		20 MIN	1	C3/F8	B401D		
	B401E	2'-4" x 7'-5 1/2"	A	WD.	1-3/4"	TRANS.	EXIST.	EXIST.	EXIST.	A		20 MIN	1	C3/F8	B401E		
	B400F	2'-0" x 6'-8"	B	WD.	1-3/4"	TRANS.	EXIST.	EXIST.	EXIST.	A		20 MIN	2	C10		9 1/2"	
	B400G	2'-0" x 6'-8"	B	WD.	1-3/4"	TRANS.	EXIST.	EXIST.	EXIST.	A		20 MIN	2	C10		9 1/2"	
	B402A	2'-0" x 6'-8"	B	WD.	1-3/4"	TRANS.	EXIST.	EXIST.	EXIST.	A		20 MIN	3	C7	B402A	9 1/2"	
	B402B	2'-0" x 6'-8"	B	WD.	1-3/4"	TRANS.	EXIST.	EXIST.	EXIST.	A		20 MIN	3	C7	B402B	9 1/2"	
	B402C	EXISTING TO REMAIN	EXIST.		EXIST.	EXIST.	H3/F8/C9		DOORS TO STAIRS PREVIOUSLY REPLACED								
	B402D	EXISTING TO REMAIN	EXIST.		EXIST.	EXIST.	H3/F8/C9		DOORS TO STAIRS PREVIOUSLY REPLACED								
	C400A	2'-4" x 7'-5 1/2"	A	WD.	1-3/4"	TRANS.	EXIST.	EXIST.	EXIST.	A		20 MIN	1	C3/F8	C400A		
	C400B	2'-4" x 7'-5 1/2"	A	WD.	1-3/4"	TRANS.	EXIST.	EXIST.	EXIST.	A		20 MIN	1	C3/F8	C400B		
	C400C	2'-4" x 7'-5 1/2"	A	WD.	1-3/4"	TRANS.	EXIST.	EXIST.	EXIST.	A		20 MIN	1	C3/F8	C400C		
	C400D	2'-4" x 7'-5 1/2"	A	WD.	1-3/4"	TRANS.	EXIST.	EXIST.	EXIST.	A		20 MIN	1	C3/F8	C400D		
	C400E	2'-0" x 6'-8"	B	WD.	1-3/4"	TRANS.	EXIST.	EXIST.	EXIST.	A		20 MIN	2	C10		9 1/2"	
	C400F	2'-0" x 6'-8"	B	WD.	1-3/4"	TRANS.	EXIST.	EXIST.	EXIST.	A		20 MIN	2	C10		9 1/2"	
	C401A	2'-4" x 7'-5 1/2"	A	WD.	1-3/4"	TRANS.	EXIST.	EXIST.	EXIST.	A		20 MIN	1	C3/F8	C401A		
	C401B	2'-4" x 7'-5 1/2"	A	WD.	1-3/4"	TRANS.	EXIST.	EXIST.	EXIST.	A		20 MIN	1	C3/F8	C401B		
	C401C	2'-4" x 7'-5 1/2"	A	WD.	1-3/4"	TRANS.	EXIST.	EXIST.	EXIST.	A		20 MIN	1	C3/F8	C401C		
	C401D	2'-4" x 7'-5 1/2"	A	WD.	1-3/4"	TRANS.	EXIST.	EXIST.	EXIST.	A		20 MIN	1	C3/F8	C401D		
	C401E	2'-0" x 6'-8"	B	WD.	1-3/4"	TRANS.	EXIST.	EXIST.	EXIST.	A		20 MIN	2	C10		9 1/2"	
	C401F	2'-0" x 6'-8"	B	WD.	1-3/4"	TRANS.	EXIST.	EXIST.	EXIST.	A		20 MIN	2	C10		9 1/2"	
	C402A	2'-0" x 6'-8"	B	WD.	1-3/4"	TRANS.	EXIST.	EXIST.	EXIST.	A		20 MIN	3	C7	C402A	9 1/2"	
	C402B	2'-0" x 6'-8"	B	WD.	1-3/4"	TRANS.	EXIST.	EXIST.	EXIST.	A		20 MIN	3	C7	C402B	9 1/2"	
	C402C	EXISTING TO REMAIN	EXIST.		EXIST.	EXIST.	H3/F8/C9		DOORS TO STAIRS PREVIOUSLY REPLACED								
	C402D	EXISTING TO REMAIN	EXIST.		EXIST.	EXIST.	H3/F8/C9		DOORS TO STAIRS PREVIOUSLY REPLACED								
	D400A	2'-4" x 7'-5 1/2"	A	WD.	1-3/4"	TRANS.	EXIST.	EXIST.	EXIST.	A		20 MIN	1	C3/F8	D400A		
	D400B	2'-4" x 7'-5 1/2"	A	WD.	1-3/4"	TRANS.	EXIST.	EXIST.	EXIST.	A		20 MIN	1	C3/F8	D400B		
	D400C	2'-4" x 7'-5 1/2"	A	WD.	1-3/4"	TRANS.	EXIST.	EXIST.	EXIST.	A		20 MIN	1	C3/F8	D400C		
	D400D	2'-4" x 7'-5 1/2"	A	WD.	1-3/4"	TRANS.	EXIST.	EXIST.	EXIST.	A		20 MIN	1	C3/F8	D400D		
	D400E	2'-0" x 6'-8"	B	WD.	1-3/4"	TRANS.	EXIST.	EXIST.	EXIST.	A		20 MIN	2	C10		9 1/2"	
	D400F	2'-0" x 6'-8"	B	WD.	1-3/4"	TRANS.	EXIST.	EXIST.	EXIST.	A		20 MIN	2	C10		9 1/2"	
	D401A	2'-4" x 7'-5 1/2"	A	WD.	1-3/4"	TRANS.	EXIST.	EXIST.	EXIST.	A		20 MIN	1	C3/F8	D401A		
	D401B	2'-4" x 7'-5 1/2"	A	WD.	1-3/4"	TRANS.	EXIST.	EXIST.	EXIST.	A		20 MIN	1	C3/F8	D401B		
	D401C	2'-4" x 7'-5 1/2"	A	WD.	1-3/4"	TRANS.	EXIST.	EXIST.	EXIST.	A		20 MIN	1	C3/F8	D401C		
	D401D	2'-4" x 7'-5 1/2"	A	WD.	1-3/4"	TRANS.	EXIST.	EXIST.	EXIST.	A		20 MIN	1	C3/F8	D401D		
	D401E	2'-4" x 7'-5 1/2"	A	WD.	1-3/4"	TRANS.	EXIST.	EXIST.	EXIST.	A		20 MIN	1	C3/F8	D401E		
	D400F	2'-0" x 6'-8"	B	WD.	1-3/4"	TRANS.	EXIST.	EXIST.	EXIST.	A		20 MIN	2	C10		9 1/2"	
	D400G	2'-0" x 6'-8"	B	WD.	1-3/4"	TRANS.	EXIST.	EXIST.	EXIST.	A		20 MIN	2	C10		9 1/2"	
	D402A	2'-0" x 6'-8"	B	WD.	1-3/4"	TRANS.	EXIST.	EXIST.	EXIST.	A		20 MIN	3	C7	D402A	9 1/2"	
	D402B	2'-0" x 6'-8"	B	WD.	1-3/4"	TRANS.	EXIST.	EXIST.	EXIST.	A		20 MIN	3	C7	D402B	9 1/2"	
	D402C	EXISTING TO REMAIN	EXIST.		EXIST.	EXIST.	H3/F8/C9		DOORS TO STAIRS PREVIOUSLY REPLACED								
	D402D	EXISTING TO REMAIN	EXIST.		EXIST.	EXIST.	H3/F8/C9		DOORS TO STAIRS PREVIOUSLY REPLACED								

NOTE: ALL GREY BOXES SHALL INDICATE A DOOR THAT IS ASSOCIATED WITH ALTERNATE #2



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Consultant




Owner

**THE UNIVERSITY OF RHODE ISLAND**

THINK BIG WE DO



Project  
**University of Rhode Island DORR HALL BATHROOM RENOVATIONS & DOOR & SIGNAGE REPLACEMENT KINGSTON, RI**

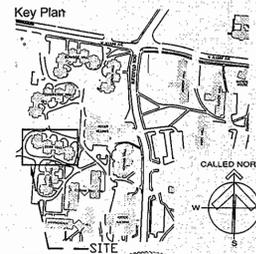

Seals



Issues

Date	Description
12/20/2012	FOR CONSTRUCTION

Revisions

No.	Date	Description
1	12/03/2012	REVIEW

Drawing Title

**SIGN & DOOR SCHEDULE & DETAILS**

Issue Date: 12/20/2012


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Project Manager: MT Production Leader: MS

Project Architect: MT Peer Reviewer: JM


Drawing Number

**A8.103**

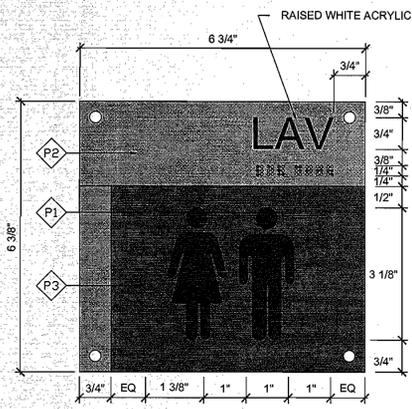


**C10 LAVATORY**  
6'=1'-0"

DEEP ACRYLIC SIGN BACK SPRAYED P2 AND P3 WITH RAISED WHITE ARIAL COPY AND BRAILLE. SYMBOLS WHITE DIRECT PRINT WITH LAMINATE. TYPICAL MOUNTING.  
APPLIES TO ALL ROOMS LABELED LAVATORY, TO BE APPLIED TO OUTSIDE OF LAV IN CORRIDOR.

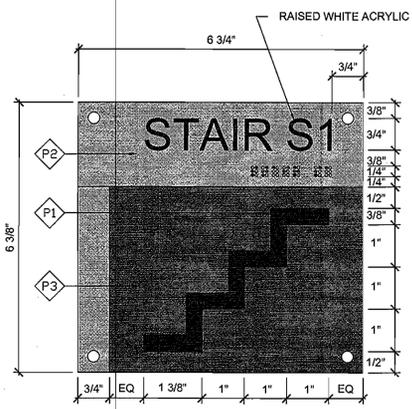


**C9 STAIRS**  
6'=1'-0"

DEEP ACRYLIC SIGN BACK SPRAYED P2 AND P3 WITH RAISED WHITE ARIAL COPY AND BRAILLE. SYMBOLS WHITE DIRECT PRINT WITH LAMINATE. TYPICAL MOUNTING.  
APPLIES TO ALL ROOMS LABELED STAIR, TO BE APPLIED TO OUTSIDE OF STAIR, IN CORRIDOR.

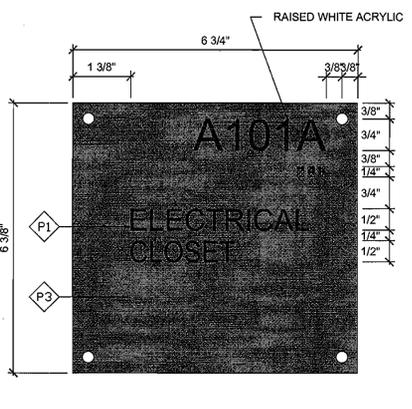


**C7 MECHANICAL / ELECTRICAL**  
6'=1'-0"

DEEP ACRYLIC SIGN BACK SPRAYED P3 WITH RAISED WHITE ARIAL COPY AND BRAILLE. WHITE SECONDARY COPY DIRECT PRINT WITH LAMINATE. TYPICAL MOUNTING.  
APPLIES TO ALL ROOMS LABELED MECH, MECHANICAL, STOR/CUST AND FIRE PROTECTION

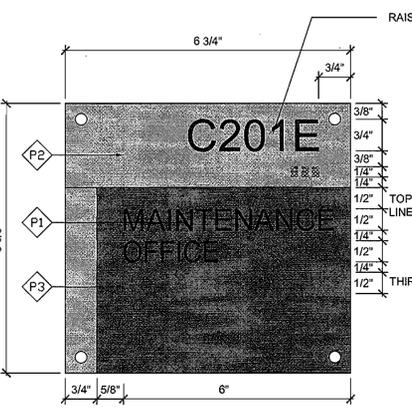


**C5 AUXILIARY SPACES / OFFICES**  
6'=1'-0"

DEEP ACRYLIC SIGN BACK SPRAYED P2 AND P3 WITH RAISED WHITE ARIAL COPY AND BRAILLE. WHITE SECONDARY COPY DIRECT PRINT WITH LAMINATE. TYPICAL MOUNTING.  
APPLIES TO ALL ROOMS LABELED OTHER THAN. REQUIRES COORDINATION WITH URI OFFICE OF RESIDENTIAL LIFE.

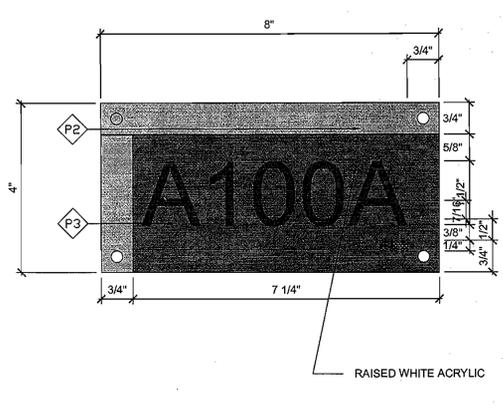

**C3 STUDENT ROOMS**  
6'=1'-0"

NOTE: PROVIDE EACH LOCATION WITH 1A  
DEEP ACRYLIC SIGN BACK SPRAYED P2 AND P3 WITH RAISED WHITE ARIAL COPY AND BRAILLE. TYPICAL MOUNTING.  
APPLIES TO ALL ROOMS LABELED OFFICE WITH TEMPORARY PERSONNEL. REQUIRES COORDINATION WITH URI OFFICE OF RESIDENTIAL LIFE.

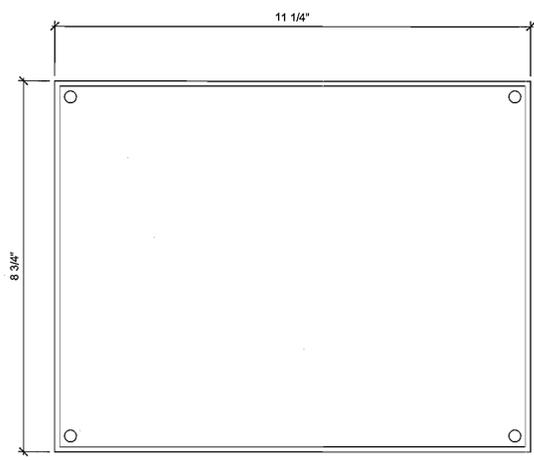

**F8 CLEAR ACRYLIC FIRE EVACUATION MAP COVER**  
6'=1'-0"


CLEAR UNBREAKABLE ACRYLIC WITH SQUARE CORNERS AND BEVELED EDGES. TYPICAL MOUNTING WITHOUT DOUBLE SIDED TAPE.  
LAMINATED PLANS PROVIDED BY OWNER.  
APPLIED TO INTERIOR OF DOOR AT EACH ROOM PER SCHEDULE.  
ALSO TO BE APPLIED IN CORRIDOR BETWEEN STAIRS

TYPICAL MOUNTING: FOUR COUNTERSUNK HOLES CENTERED AT 3/8" FROM THE CORNERS WITH #6 FLAT TOP TORX SCREWS WITH PIN. PRE-DRILL AND PROVIDE EXPANSION ANCHORS. USE 1/32" BLACK FOAM DOUBLE SIDED TAPE TO ATTACH SIGNAGE TO WALL. INSET TAPE 3/8" FROM EDGES OF PLATE AT FULL PERIMETER OF SIGN.

**PAINT & FINISH SCHEDULE**

THIS SCHEDULE PROVIDES COLOR MATCHING INFORMATION FOR ALL SIGNS AND GRAPHICS SPECIFIED IN THE SIGN CONSTRUCTION DRAWINGS. PAINT COLORS ARE IDENTIFIED ON THE DRAWINGS WITH DIAMOND TAGS CONTAINING A LETTER AND NUMBER. LISTED BELOW ARE THE TAGS WITH COLOR REFERENCES FOR USE IN MATCHING PAINT. SEE SIGN SPECIFICATIONS FOR PAINT MANUFACTURER AND FINISH INFORMATION.


- PROGRAM COLORS & MATERIAL FINISHES
- ◇ P1 WHITE
  - ◇ P2 MP 15681 (LIGHT GRAY)
  - ◇ P3 MP 18214 (DARK GRAY)

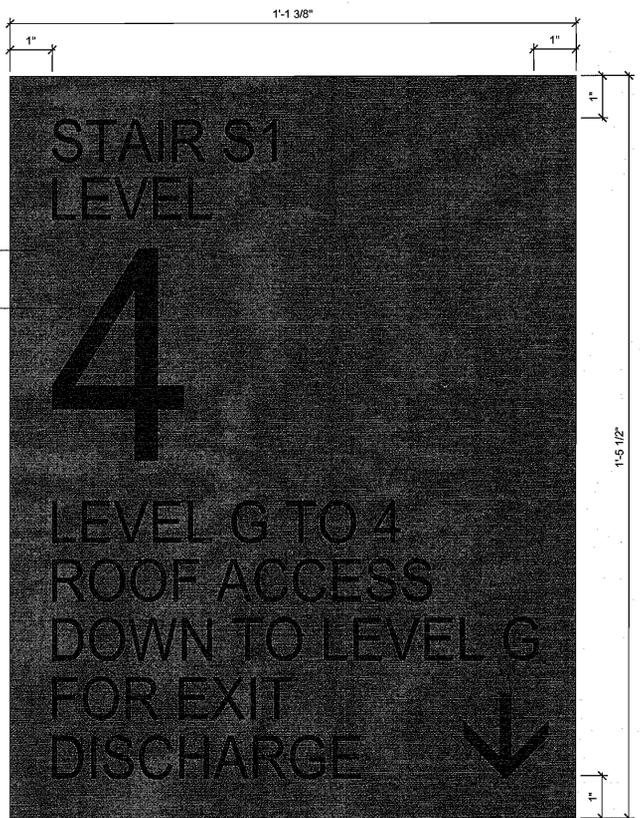

**H3 STAIRWELL**  
6'=1'-0"

APPLIES TO ALL ROOMS LABELED STAIR, TO BE APPLIED INSIDE OF STAIRWELL AT EACH LEVEL. REQUIRES COORDINATION WITH URI OFFICE OF RESIDENTIAL LIFE.

DEMOLITION NOTES:  
REMOVE EXISTING SIGNS FASTENERS AND ADHESIVES FROM LOCATIONS WHERE NEW SIGNAGE IS SCHEDULED.  
REMOVE DOORS AND ASSOCIATED HARDWARE WHERE INDICATED TO BE NEW. SALVAGE LOCKSETS AND RETURN TO OWNER. EXISTING FRAMES TO REMAIN.

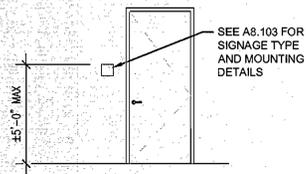

NOTE:  
SIGNS MUST BE LOCATED ON THE LOCKSET SIDE OF DOOR, BETWEEN MINIMUM 3" TO MAXIMUM 11" AWAY FROM DOOR FRAME, ALIGNED WITH JOINTS OF INTERIOR WALL FINISH. LOCATIONS WILL VARY DEPENDING ON RELATION OF DOOR TO WALL FINISH.

**H10 SIGNAGE MOUNTING LOCATION**  
N.T.S.

**TectonArchitects inc**  
1 Hartford Sq. West, Hartford CT 06106  
860 548 0802  
17 Railroad Avenue, Westerly RI 02891  
401 596 7555  
tectonarchitects.com

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Owner  
**THE UNIVERSITY OF RHODE ISLAND**



Project  
**University of Rhode Island DORR HALL BATHROOM RENOVATIONS & DOOR & SIGNAGE REPLACEMENT KINGSTON, RI**



Issues

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**SIGNAGE & MOUNTING DETAILS**

Issue Date: 12/20/2012  
Project No: KC-R ROOM 2010-001 Scale: AS NOTED  
Project Manager: MT Production Leader: MS  
Project Architect: MT Peer Reviewer: JM

Drawing Number  
**A8.104**

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Consultant




Owner  
**THE UNIVERSITY OF RHODE ISLAND**

**THINK BIG WE DO**



Project  
**University of Rhode Island DORR HALL BATHROOM RENOVATIONS & DOOR & SIGNAGE REPLACEMENT KINGSTON, RI**

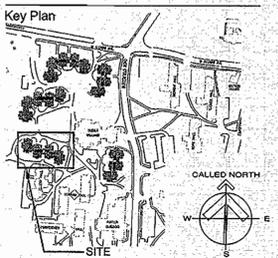

Seals  
 RICHARD C. NEWELL  
 No. 8486  
 REGISTERED PROFESSIONAL ENGINEER MECHANICAL

Issues  
 Date

12/20/2012 CONSTRUCTION DOCUMENTS

Revisions	No.	Date	Description


Drawing Title  
**GROUND LEVEL FLOOR PLAN PLUMBING DEMOLITION**

Issue Date: 12/20/2012  
 Project No: UR1161N Scale: AS NOTED  
 Project Manager: WMS Production Leader: MS  
 Project Architect: MT Peer Reviewer: RCN

Drawing Number

**P1.101**

CEC# 2012126

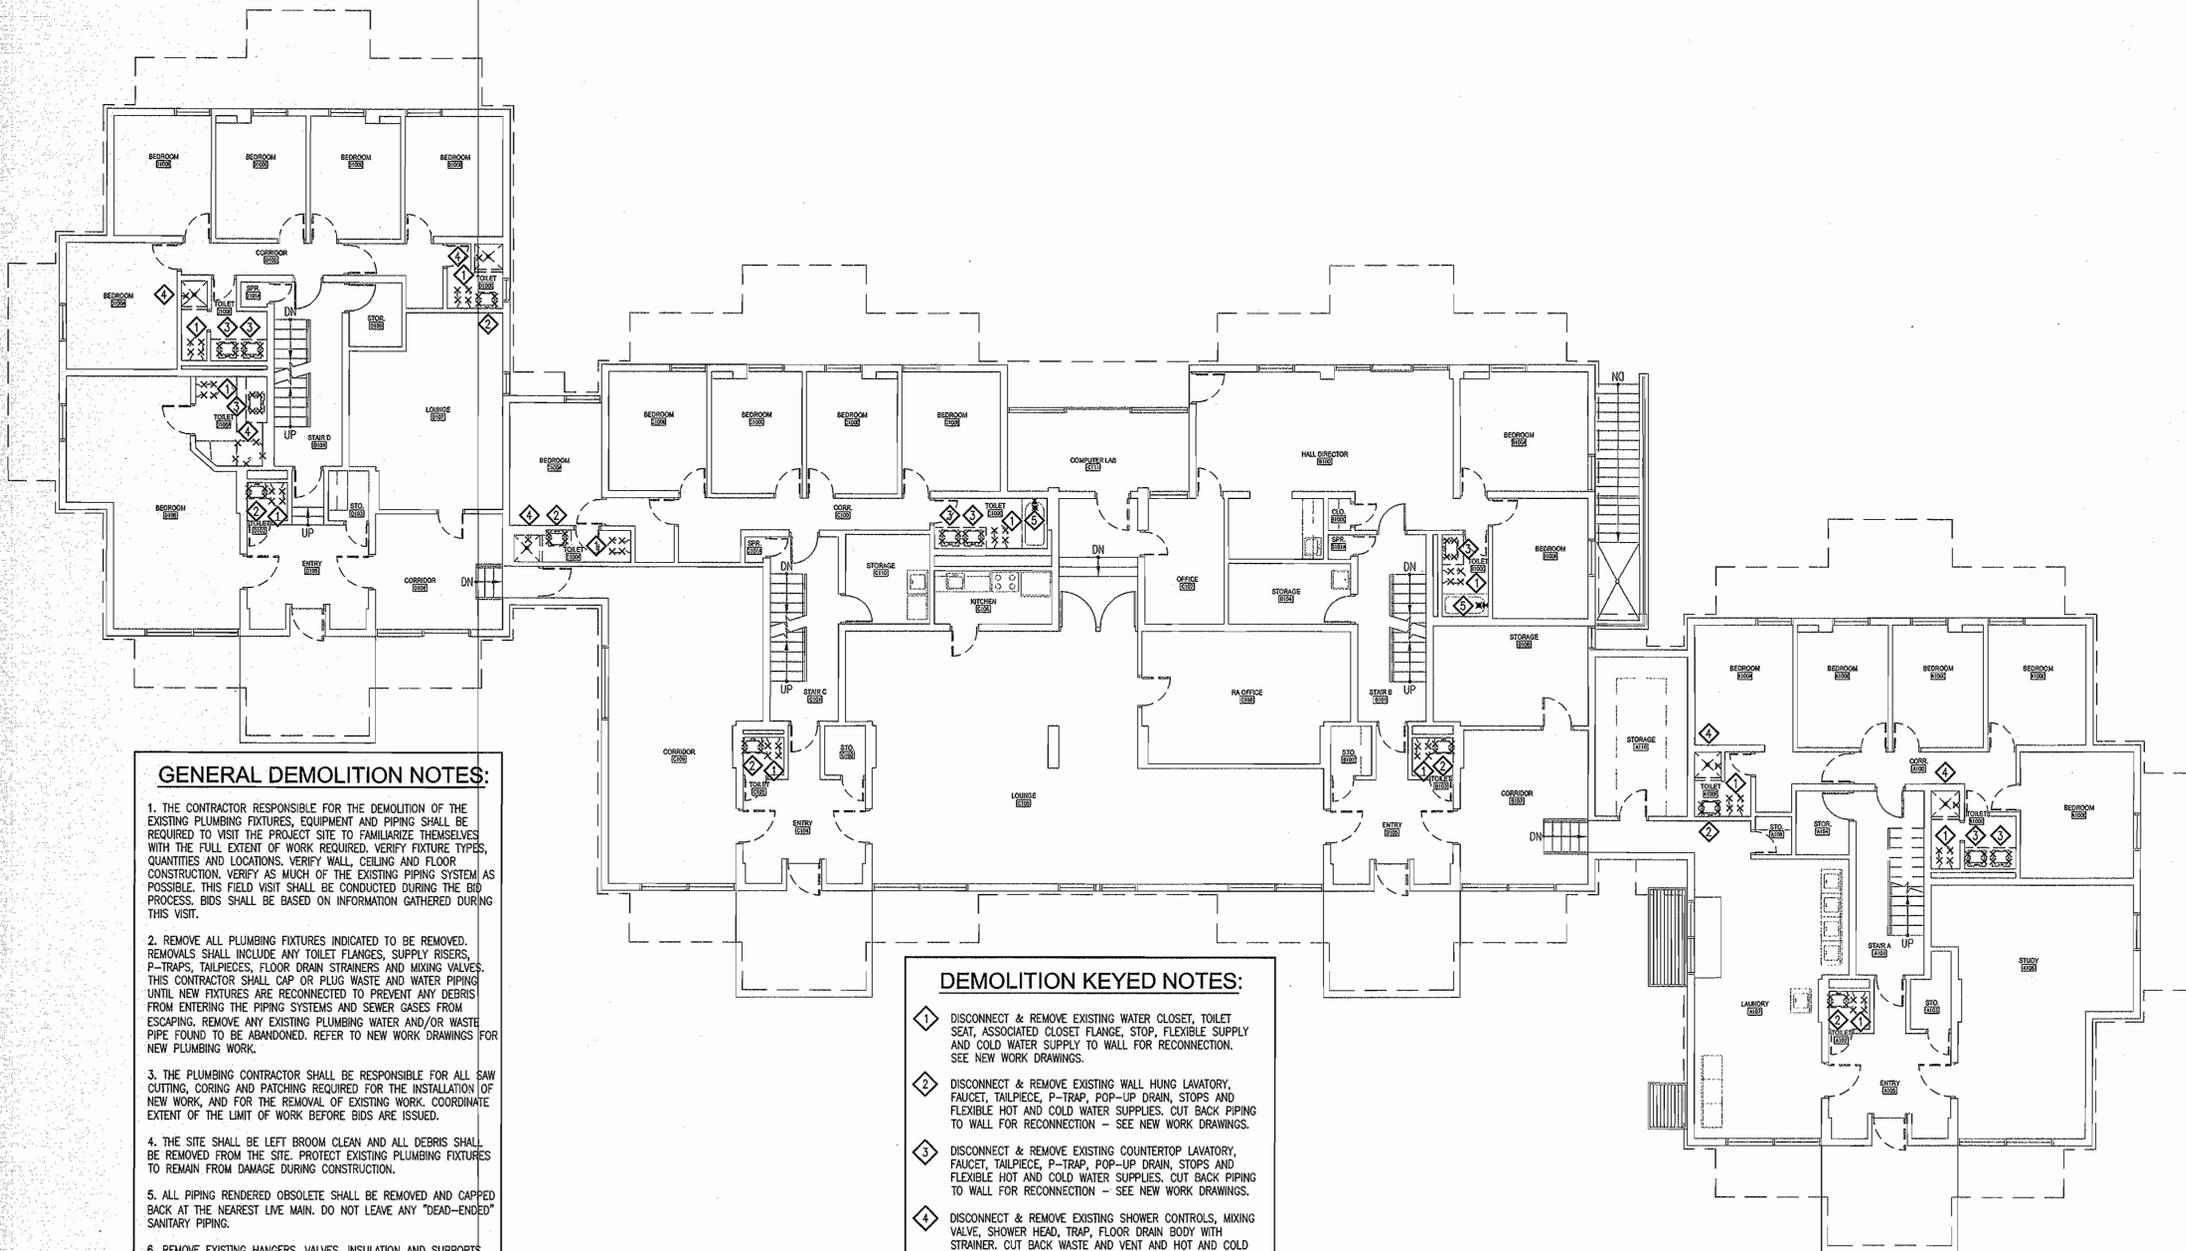


**GENERAL DEMOLITION NOTES:**

1. THE CONTRACTOR RESPONSIBLE FOR THE DEMOLITION OF THE EXISTING PLUMBING FIXTURES, EQUIPMENT AND PIPING SHALL BE REQUIRED TO VISIT THE PROJECT SITE TO FAMILIARIZE THEMSELVES WITH THE FULL EXTENT OF WORK REQUIRED. VERIFY FIXTURE TYPES, QUANTITIES AND LOCATIONS. VERIFY WALL, CEILING AND FLOOR CONSTRUCTION. VERIFY AS MUCH OF THE EXISTING PIPING SYSTEM AS POSSIBLE. THIS FIELD VISIT SHALL BE CONDUCTED DURING THE BID PROCESS. BIDS SHALL BE BASED ON INFORMATION GATHERED DURING THIS VISIT.
2. REMOVE ALL PLUMBING FIXTURES INDICATED TO BE REMOVED. REMOVALS SHALL INCLUDE ANY TOILET FLANGES, SUPPLY RISERS, P-TRAPS, TAILPIECES, FLOOR DRAIN STRAINERS AND MIXING VALVES. THIS CONTRACTOR SHALL CAP OR PLUG WASTE AND WATER PIPING UNTIL NEW FIXTURES ARE RECONNECTED TO PREVENT ANY DEBRIS FROM ENTERING THE PIPING SYSTEMS AND SEWER GASES FROM ESCAPING. REMOVE ANY EXISTING PLUMBING WATER AND/OR WASTE PIPE FOUND TO BE ABANDONED. REFER TO NEW WORK DRAWINGS FOR NEW PLUMBING WORK.
3. THE PLUMBING CONTRACTOR SHALL BE RESPONSIBLE FOR ALL SAW CUTTING, CORING AND PATCHING REQUIRED FOR THE INSTALLATION OF NEW WORK, AND FOR THE REMOVAL OF EXISTING WORK. COORDINATE EXTENT OF THE LIMIT OF WORK BEFORE BIDS ARE ISSUED.
4. THE SITE SHALL BE LEFT BROOM CLEAN AND ALL DEBRIS SHALL BE REMOVED FROM THE SITE. PROTECT EXISTING PLUMBING FIXTURES TO REMAIN FROM DAMAGE DURING CONSTRUCTION.
5. ALL PIPING RENDERED OBSOLETE SHALL BE REMOVED AND CAPPED BACK AT THE NEAREST LIVE MAIN. DO NOT LEAVE ANY "DEAD-ENDED" SANITARY PIPING.
6. REMOVE EXISTING HANGERS, VALVES, INSULATION AND SUPPORTS ASSOCIATED WITH PIPING THAT IS BEING REMOVED.
7. EXISTING PLUMBING FIXTURES BEING REMOVED SHALL BE TURNED OVER TO OWNER. VERIFY WITH OWNER WHICH ITEMS ARE TO BE STORED AND WHERE, AND WHICH ITEMS ARE TO BE DISPOSED OF.

**DEMOLITION KEYED NOTES:**

- 1 DISCONNECT & REMOVE EXISTING WATER CLOSET, TOILET SEAT, ASSOCIATED CLOSET FLANGE, STOP, FLEXIBLE SUPPLY AND COLD WATER SUPPLY TO WALL FOR RECONNECTION. SEE NEW WORK DRAWINGS.
- 2 DISCONNECT & REMOVE EXISTING WALL HUNG LAVATORY, FAUCET, TAILPIECE, P-TRAP, POP-UP DRAIN, STOPS AND FLEXIBLE HOT AND COLD WATER SUPPLIES. CUT BACK PIPING TO WALL FOR RECONNECTION - SEE NEW WORK DRAWINGS.
- 3 DISCONNECT & REMOVE EXISTING COUNTERTOP LAVATORY, FAUCET, TAILPIECE, P-TRAP, POP-UP DRAIN, STOPS AND FLEXIBLE HOT AND COLD WATER SUPPLIES. CUT BACK PIPING TO WALL FOR RECONNECTION - SEE NEW WORK DRAWINGS.
- 4 DISCONNECT & REMOVE EXISTING SHOWER CONTROLS, MIXING VALVE, SHOWER HEAD, TRAP, FLOOR DRAIN BODY WITH STRAINER. CUT BACK WASTE AND VENT AND HOT AND COLD WATER TO WALL FOR RECONNECTION - SEE NEW WORK DRAWINGS.
- 5 DISCONNECT & REMOVE EXISTING SHOWER/TUB CONTROLS, MIXING VALVE, SHOWER HEAD, TUB DRAIN, AND STRAINER. CUT BACK WASTE AND VENT AND HOT AND COLD WATER TO WALL FOR RECONNECTION - SEE NEW WORK DRAWINGS.

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**GENERAL DEMOLITION NOTES:**

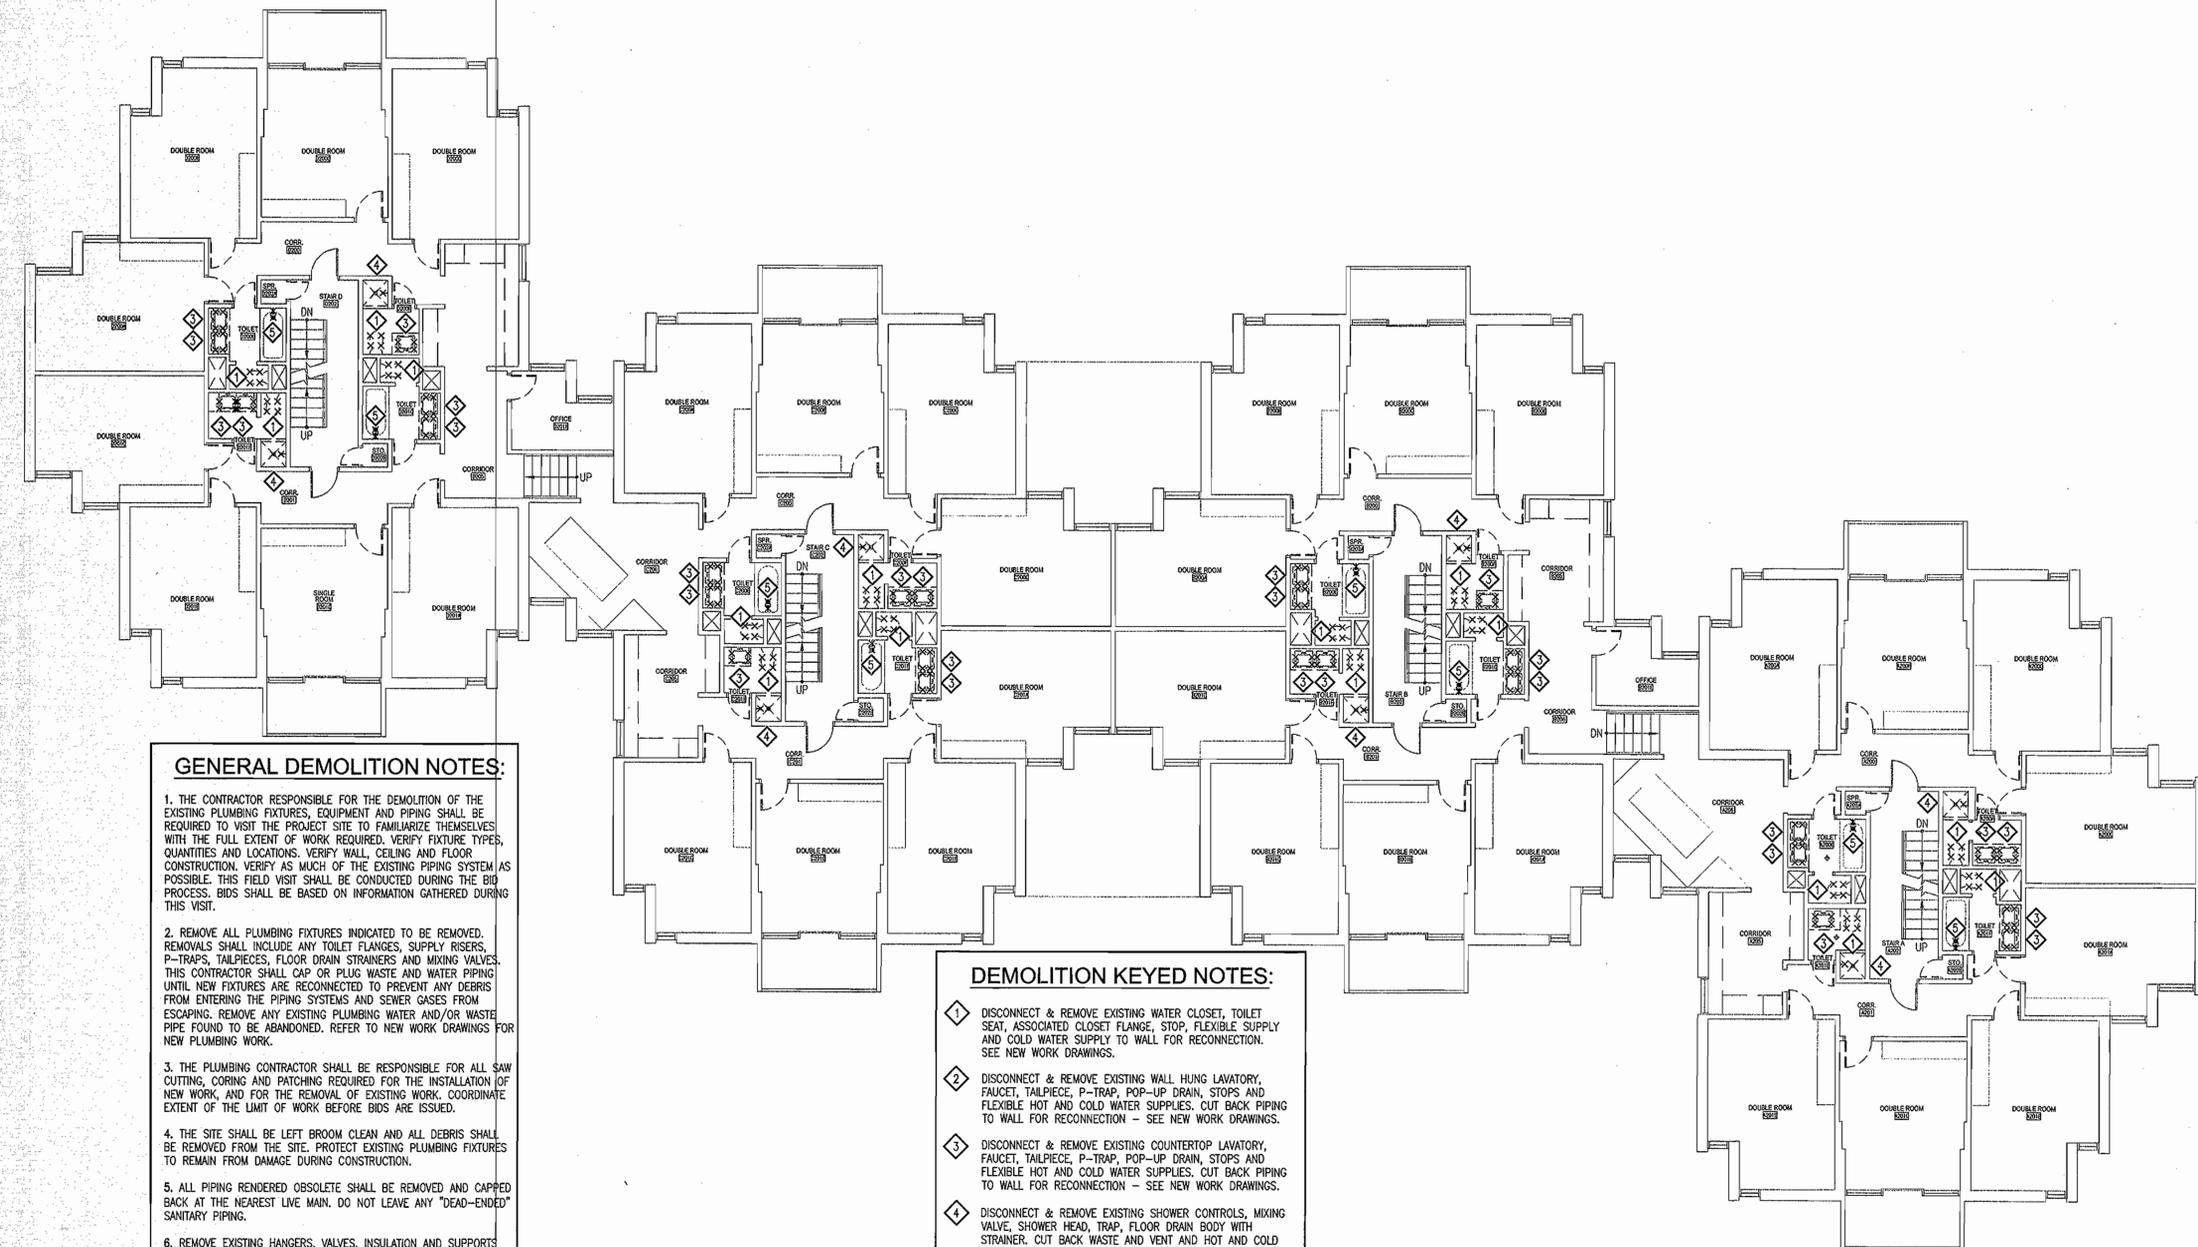1. THE CONTRACTOR RESPONSIBLE FOR THE DEMOLITION OF THE EXISTING PLUMBING FIXTURES, EQUIPMENT AND PIPING SHALL BE REQUIRED TO VISIT THE PROJECT SITE TO FAMILIARIZE THEMSELVES WITH THE FULL EXTENT OF WORK REQUIRED. VERIFY FIXTURE TYPES, QUANTITIES AND LOCATIONS. VERIFY WALL, CEILING AND FLOOR CONSTRUCTION. VERIFY AS MUCH OF THE EXISTING PIPING SYSTEM AS POSSIBLE. THIS FIELD VISIT SHALL BE CONDUCTED DURING THE BID PROCESS. BIDS SHALL BE BASED ON INFORMATION GATHERED DURING THIS VISIT.
2. REMOVE ALL PLUMBING FIXTURES INDICATED TO BE REMOVED. REMOVALS SHALL INCLUDE ANY TOILET FLANGES, SUPPLY RISERS, P-TRAPS, TAILPIECES, FLOOR DRAIN STRAINERS AND MIXING VALVES. THIS CONTRACTOR SHALL CAP OR PLUG WASTE AND WATER PIPING UNTIL NEW FIXTURES ARE RECONNECTED TO PREVENT ANY DEBRIS FROM ENTERING THE PIPING SYSTEMS AND SEWER GASES FROM ESCAPING. REMOVE ANY EXISTING PLUMBING WATER AND/OR WASTE PIPE FOUND TO BE ABANDONED. REFER TO NEW WORK DRAWINGS FOR NEW PLUMBING WORK.
3. THE PLUMBING CONTRACTOR SHALL BE RESPONSIBLE FOR ALL SAW CUTTING, CORING AND PATCHING REQUIRED FOR THE INSTALLATION OF NEW WORK, AND FOR THE REMOVAL OF EXISTING WORK. COORDINATE EXTENT OF THE LIMIT OF WORK BEFORE BIDS ARE ISSUED.
4. THE SITE SHALL BE LEFT BROOM CLEAN AND ALL DEBRIS SHALL BE REMOVED FROM THE SITE. PROTECT EXISTING PLUMBING FIXTURES TO REMAIN FROM DAMAGE DURING CONSTRUCTION.
5. ALL PIPING RENDERED OBSOLETE SHALL BE REMOVED AND CAPPED BACK AT THE NEAREST LIVE MAIN. DO NOT LEAVE ANY "DEAD-ENDED" SANITARY PIPING.
6. REMOVE EXISTING HANGERS, VALVES, INSULATION AND SUPPORTS ASSOCIATED WITH PIPING THAT IS BEING REMOVED.
7. EXISTING PLUMBING FIXTURES BEING REMOVED SHALL BE TURNED OVER TO OWNER. VERIFY WITH OWNER WHICH ITEMS ARE TO BE STORED AND WHERE, AND WHICH ITEMS ARE TO BE DISPOSED OF.

**DEMOLITION KEYED NOTES:**

- 1 DISCONNECT & REMOVE EXISTING WATER CLOSET, TOILET SEAT, ASSOCIATED CLOSET FLANGE, STOP, FLEXIBLE SUPPLY AND COLD WATER SUPPLY TO WALL FOR RECONNECTION - SEE NEW WORK DRAWINGS.
- 2 DISCONNECT & REMOVE EXISTING WALL HUNG LAVATORY, FAUCET, TAILPIECE, P-TRAP, POP-UP DRAIN, STOPS AND FLEXIBLE HOT AND COLD WATER SUPPLIES. CUT BACK PIPING TO WALL FOR RECONNECTION - SEE NEW WORK DRAWINGS.
- 3 DISCONNECT & REMOVE EXISTING COUNTERTOP LAVATORY, FAUCET, TAILPIECE, P-TRAP, POP-UP DRAIN, STOPS AND FLEXIBLE HOT AND COLD WATER SUPPLIES. CUT BACK PIPING TO WALL FOR RECONNECTION - SEE NEW WORK DRAWINGS.
- 4 DISCONNECT & REMOVE EXISTING SHOWER CONTROLS, MIXING VALVE, SHOWER HEAD, TRAP, FLOOR DRAIN BODY WITH STRAINER. CUT BACK WASTE AND VENT AND HOT AND COLD WATER TO WALL FOR RECONNECTION - SEE NEW WORK DRAWINGS.
- 5 DISCONNECT & REMOVE EXISTING SHOWER/TUB CONTROLS, MIXING VALVE, SHOWER HEAD, TUB DRAIN, AND STRAINER. CUT BACK WASTE AND VENT AND HOT AND COLD WATER TO WALL FOR RECONNECTION - SEE NEW WORK DRAWINGS.

**H10 SECOND, THIRD & FOURTH LEVEL FLOOR PLAN - PLUMBING DEMOLITION**  
SCALE: 1/8"=1'-0"

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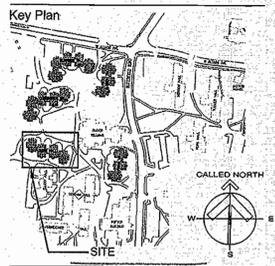
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Project  
University of Rhode Island  
**DORR HALL**  
**BATHROOM RENOVATIONS & DOOR & SIGNAGE REPLACEMENT**  
KINGSTON, RI



Seals

**RICHARD C. NEWELL**  
No. 8486  
REGISTERED 8.13  
PROFESSIONAL ENGINEER  
MECHANICAL

Issues

Date	Description
12/20/2012	CONSTRUCTION DOCUMENTS

Revisions

No.	Date	Description

Drawing Title  
**SECOND, THIRD, & FOURTH FLOORS PLUMBING DEMOLITION**

Issue Date: 12/20/2012

Project No: UR16N Scale: AS NOTED

Project Manager: WMS Production Leader: MS

Project Architect: MT Peer Reviewer: RCN

Drawing Number

**P1.102**

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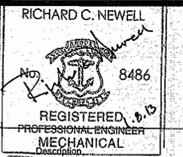
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Project  
**University of Rhode Island  
 DORR HALL  
 BATHROOM RENOVATIONS &  
 DOOR & SIGNAGE REPLACEMENT  
 KINGSTON, RI**



Seals



**RICHARD C. NEWELL**  
 No. 8486  
 REGISTERED PROFESSIONAL ENGINEER  
 MECHANICAL

Issues

Date	Description

Revisions

No.	Date	Description

Drawing Title


**GROUND LEVEL  
 FLOOR PLAN  
 PLUMBING**

Issue Date:	12/20/2012
Project No:	UR116IN
Scale:	AS NOTED
Project Manager:	WMS
Production Leader:	MS
Project Architect:	MT
Peer Reviewer:	RCN

Drawing Number

**P2.201**

CEC# 2012126

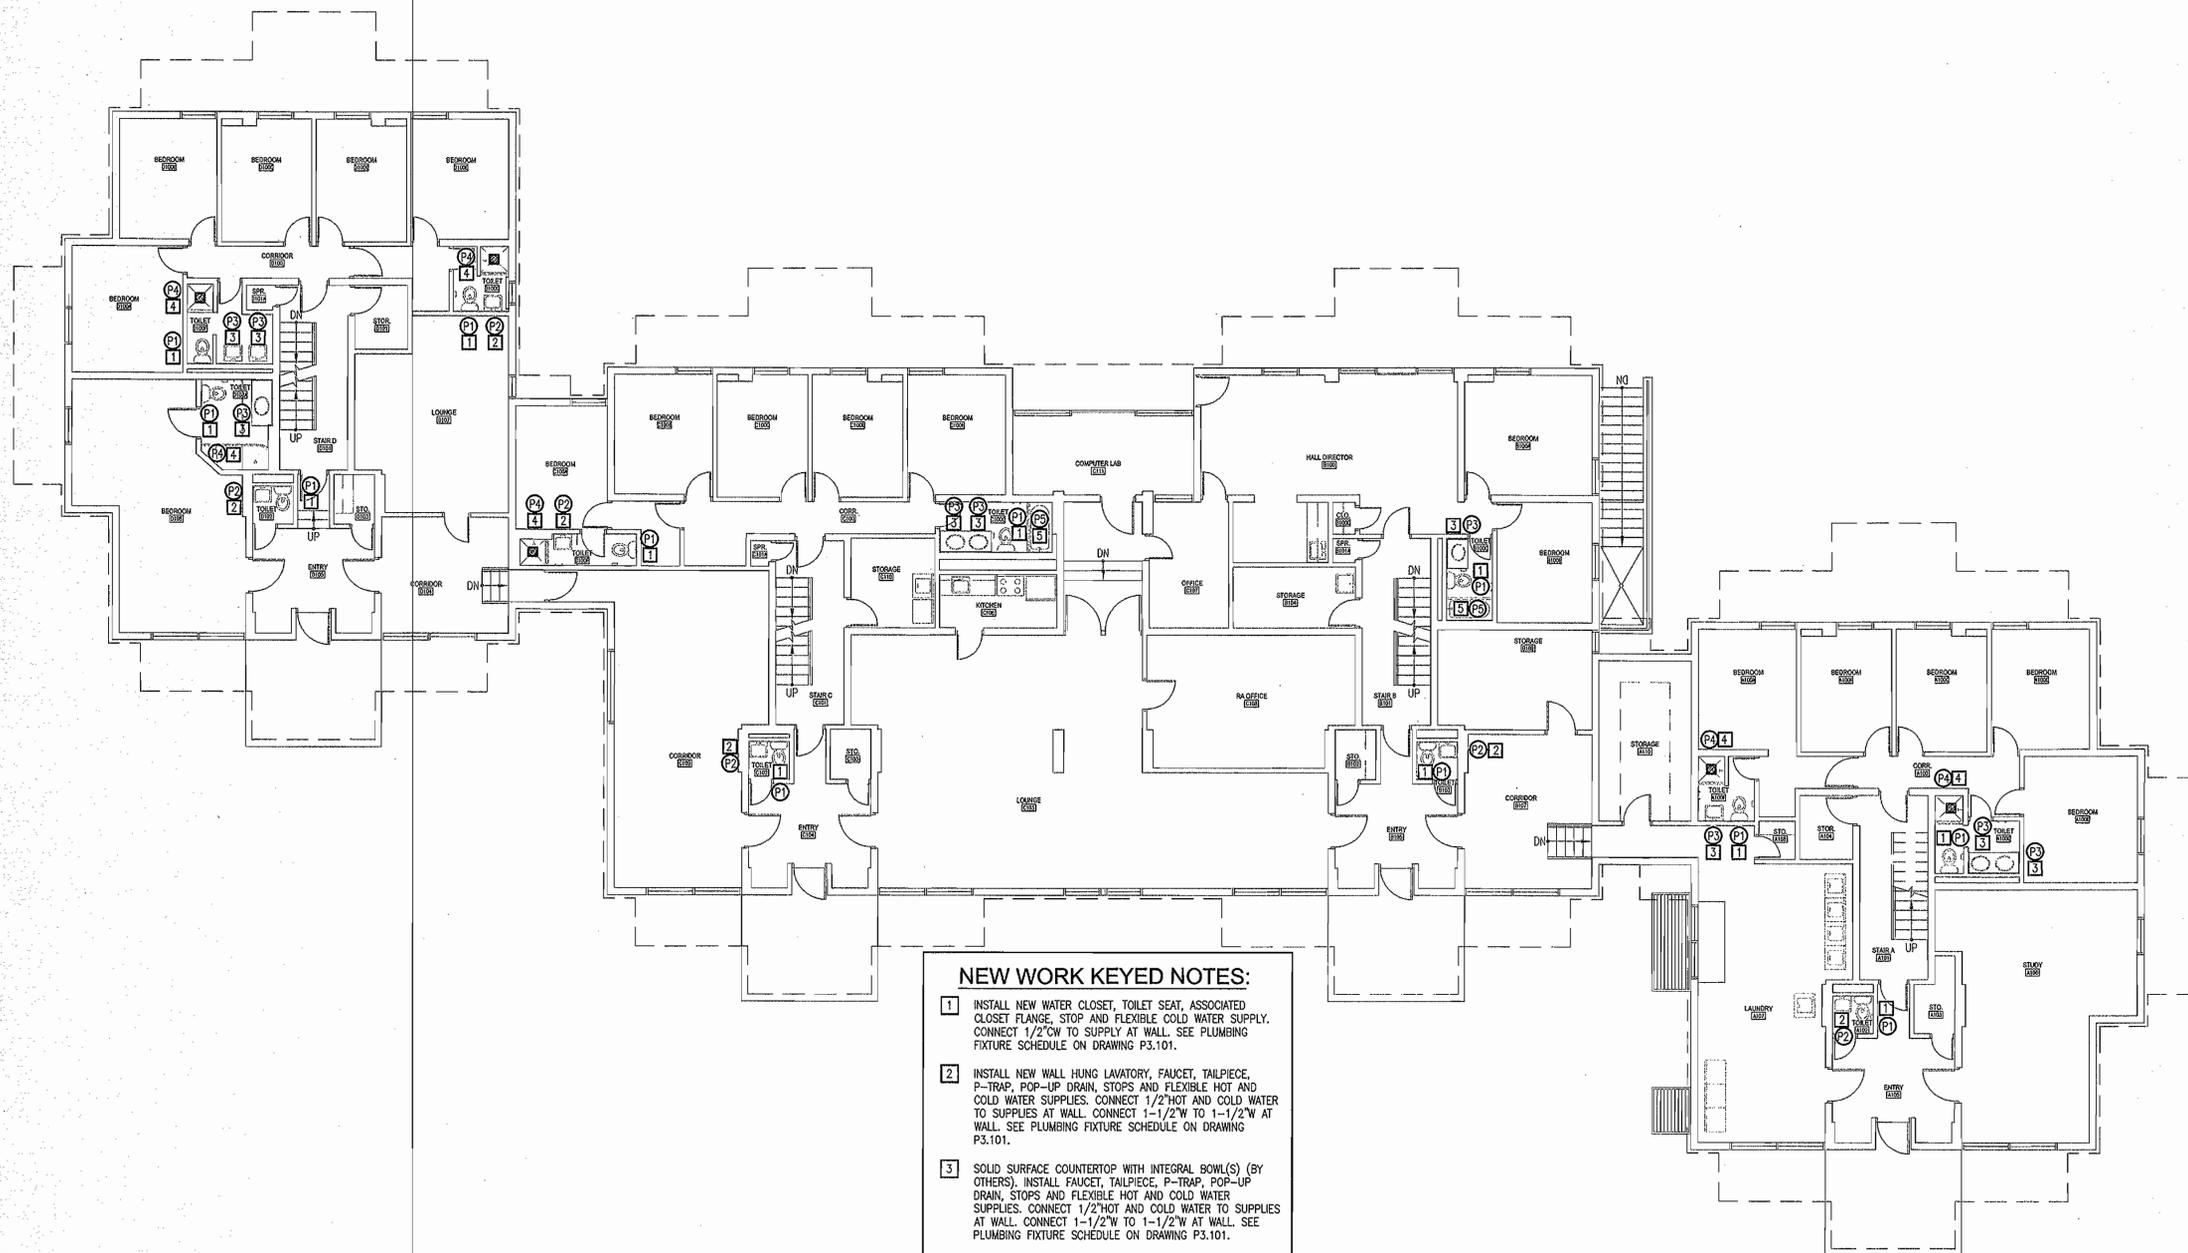

- NEW WORK KEYED NOTES:**
1. INSTALL NEW WATER CLOSET, TOILET SEAT, ASSOCIATED CLOSET FLANGE, STOP AND FLEXIBLE COLD WATER SUPPLY. CONNECT 1/2" CW TO SUPPLY AT WALL. SEE PLUMBING FIXTURE SCHEDULE ON DRAWING P3.101.
  2. INSTALL NEW WALL HUNG LAVATORY, FAUCET, TAILPIECE, P-TRAP, POP-UP DRAIN, STOPS AND FLEXIBLE HOT AND COLD WATER SUPPLIES. CONNECT 1/2" HOT AND COLD WATER TO SUPPLIES AT WALL. CONNECT 1-1/2" W TO 1-1/2" W AT WALL. SEE PLUMBING FIXTURE SCHEDULE ON DRAWING P3.101.
  3. SOLID SURFACE COUNTERTOP WITH INTEGRAL SINK(S) (BY OTHERS). INSTALL FAUCET, TAILPIECE, P-TRAP, POP-UP DRAIN, STOPS AND FLEXIBLE HOT AND COLD WATER SUPPLIES. CONNECT 1/2" HOT AND COLD WATER TO SUPPLIES AT WALL. CONNECT 1-1/2" W TO 1-1/2" W AT WALL. SEE PLUMBING FIXTURE SCHEDULE ON DRAWING P3.101.
  4. SHOWER BASE AND SURROUND (BY OTHERS). INSTALL NEW SHOWER HEAD, MIXING VALVE, AND FLOOR DRAIN. CONNECT 1/2" HOT AND COLD WATER TO HW AND CW IN WALL. CONNECT NEW 2" P-TRAP TO EXISTING 2" W ABOVE CEILING BELOW. SEE PLUMBING FIXTURE SCHEDULE ON DRAWING P3.101.
  5. BATHTUB AND SURROUND (BY OTHERS). INSTALL NEW SHOWER HEAD, MIXING VALVE, TUB SPOUT AND TRIP LEVER BATHTUB DRAIN. CONNECT 1/2" HOT AND COLD WATER TO HW AND CW IN WALL. CONNECT NEW 2" W TO EXISTING 2" W ABOVE CEILING BELOW. SEE PLUMBING FIXTURE SCHEDULE ON DRAWING P3.101.

**GROUND LEVEL FLOOR PLAN - PLUMBING**  
 SCALE: 1/8" = 1'-0"



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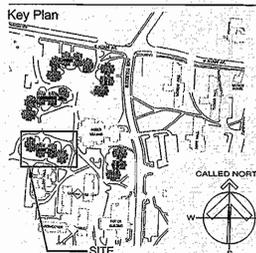


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Project  
**University of Rhode Island DORR HALL BATHROOM RENOVATIONS & DOOR & SIGNAGE REPLACEMENT KINGSTON, RI**



Seals  
 RICHARD C. NEWELL  
 8486  
 REGISTERED PROFESSIONAL ENGINEER  
 MECHANICAL

Issues  
 Date

12/20/2012 CONSTRUCTION DOCUMENTS

Revisions	No.	Date	Description

Drawing Title  
**LEGEND AND SCHEDULES - PLUMBING**

Issue Date: 12/20/2012  
 Project No: UR11616 Scale: AS NOTED  
 Project Manager: WMS Production Leader: MS  
 Project Architect: MT Peer Reviewer: RCN

Drawing Number  
**P3.101**  
 CEC# 2012126

**PLUMBING FIXTURE SCHEDULE**

SYMBOL	DESCRIPTION	CONNECTIONS				FIXTURE	FITTINGS	REMARKS
		WASTE	VENT	HOT WATER	COLD WATER			
(P1)	TANK TYPE WATER CLOSET	4"	2"	-	1/2"	KOHLER # 3880	USE METAL CLOSET FLANGE - SECURE FLANGE TO CONCRETE FLOOR	VITREOUS CHINA, FLOOR MOUNTED, TANK TYPE WATER CLOSET WITH ROUND RIM WITH MATCHING ROUND SOFTCLOSE SEAT AND COVER #K-4658. 1.6 GALLON GALLONS PER FLUSH. PROVIDE "MCGUIRE" HEAVY DUTY STOP AND CHROME PLATED SUPPLY. VERIFY EXISTING ROUGH-IN WASTE DIMENSION MATCHES NEW ROUGH-IN WASTE DIMENSION BEFORE ORDERING FIXTURE.
(P2)	WALL HUNG LAVATORY	1-1/2"	1-1/2"	1/2"	1/2"	TOTO # LT307.4	SYMMONS # S-250-LWG	VITREOUS CHINA, WALL HUNG LAVATORY. CHROME PLATED, SINGLE LEVER, 4" CENTERS FAUCET FLOWING AT 2.2 GPM. PROVIDE POP UP DRAIN WITH LIFT ROD. PROVIDE "MCGUIRE" HEAVY DUTY STOPS, SUPPLIES, TRAP & TAILPIECE.
(P3)	COUNTERTOP LAVATORY	1-1/2"	1-1/2"	1/2"	1/2"	SOLID SURFACE COUNTER WITH INTEGRAL BOWL(S) (BY OTHERS)	SYMMONS # S-250-LWG	SOLID SURFACE COUNTER WITH INTEGRAL BOWL(S) (BY OTHERS). CHROME PLATED, SINGLE LEVER, 4" CENTERS FAUCET FLOWING AT 2.2 GPM. PROVIDE POP UP DRAIN. PROVIDE "MCGUIRE" HEAVY DUTY STOPS, SUPPLIES, TRAP & TAILPIECE.
(P4)	SHOWER	2"	2"	1/2"	1/2"	SHOWER BASE & SURROUND (BY OTHERS)	SYMMONS # S-96-1-X FDT - SEE SCHEDULE	SHOWER BASE & SURROUND BY OTHERS. SHOWER CONTROLS WITH INTEGRAL STOPS.
(P5)	BATHTUB	2"	2"	1/2"	1/2"	BATHTUB & SURROUND (BY OTHERS)	SYMMONS # S-96-2-X WATCO # 501TL	BATHTUB & SURROUND BY OTHERS. SHOWER / BATHTUB CONTROLS WITH INTEGRAL STOPS AND DIVERTER. INCLUDE TRIP LEVER BATHTUB DRAIN.

**FLOOR DRAIN AND CLEANOUT SCHEDULE**

TYPE	SIZE	LOCATION	MODEL #	REMARKS
FD1	2"	SHOWERS AND ALTERNATE NO. 1	ZURN # ZN-415-S-EF-DP-VP	DURA-COATED CAST IRON BODY W/ BOTTOM OUTLET, 6" TYPE "S" DECORATIVE POLISHED NICKLE BRONZE STRAINER, VANDAL-PROOF SECURED TOP. COORDINATE INSTALLATION W/ COPPER PAN. ALTERNATE NO. 1 SHALL INCLUDE 2" "SURE SEAL" NEOPRENE TRAP SEAL SET IN FLOOR DRAIN.

**PLUMBING LEGEND**

SYMBOL	ABBR.	DESCRIPTION
=====	S/W	SOIL/WASTE PIPE BELOW SLAB
==	V	VENT PIPE BELOW SLAB
-----	S/W	SOIL/WASTE PIPE ABOVE SLAB
- - - - -	V	VENT PIPE ABOVE FLOOR SLAB
-----	CW	COLD WATER PIPE
-----	HW	HOT WATER PIPE
-----	HWR	HOT WATER RETURN PIPE
(X)		REMOVE EXISTING PLUMBING FIXTURE
(FD)	FD	FLOOR DRAIN - SEE SCHEDULE
(CTE)	CTE	CONNECT TO EXISTING PLUMBING FIXTURE DESIGNATION
(D)		DEMOLITION KEYED NOTE
(N)		NEW WORK KEYED NOTE
(ETR)	ETR	EXISTING TO REMAIN
(VF)	VF	VERIFY LOCATION, SIZE & FLOW IN FIELD
(TYP)	TYP	TYPICAL

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Project  
**University of Rhode Island DORR HALL BATHROOM RENOVATIONS & DOOR & SIGNAGE REPLACEMENT KINGSTON, RI**



Seals  
 REGISTERED PROFESSIONAL ENGINEER  
 ELECTRICAL  
 Robert D. Dorr  
 No. 7230  
 1-8-13

Issues

Date	Description

12/20/2012 CONSTRUCTION DOCUMENTS

Revisions

No.	Date	Description

Drawing Title

**GROUND LEVEL ELECTRICAL PLAN**

Issue Date: 12/20/2012

Project No: URI16IN Scale: AS NOTED

Project Manager: WMS Production Leader: WMS

Project Architect: Peer Reviewer: PDS

Drawing Number

**E2.101**


CEC# 2012126

**ELECTRICAL SYMBOL LEGEND**

-  FLUORESCENT LIGHTING FIXTURE
-  FLUORESCENT LIGHTING FIXTURE
-  SINGLE POLE SWITCH
-  FIRE ALARM STROBE ONLY
-  DUPLEX RECEPTACLE

**SHEET NOTES:**

- 1 REMOVE EXISTING FIRE ALARM STROBE ONLY DEVICE AND BACKBOX, AND REINSTALL IN SAME LOCATION ON NEW SURFACE. PROVIDE ALL NECESSARY HARDWARE AND ALL FINAL TERMINATIONS.
- 2 REMOVE EXISTING WALL MOUNTED 4' LINEAR FLUORESCENT AND REPLACE WITH NEW MERCURY LIGHTING #MF38-WW-232-AFW-ELB-HP-UNI. PROVIDE ALL NECESSARY HARDWARE AND ALL FINAL TERMINATIONS.
- 3 REMOVE EXISTING SINGLE POLE WALL SWITCH AND COVERPLATE AND REPLACE WITH NEW. PROVIDE ALL NECESSARY HARDWARE AND ALL FINAL TERMINATIONS.
- 4 REMOVE EXISTING SURFACE MOUNTED CEILING LIGHT FIXTURE AND REPLACE WITH NEW MERCURY LIGHTING #MF38-WW-217-AFW-ELB-HP-UNI. PROVIDE ALL NECESSARY HARDWARE AND ALL FINAL TERMINATIONS.
- 5 PROVIDE NEW GFI RECEPTACLE AND COVERPLATE IN NEW SURFACE MOUNTED IVORY WIREMOLD BOX. MOUNT AT 6" ABOVE COUNTERTOP. PROVIDE NEW (2)#12 & (1)#12G, IN NEW SURFACE MOUNTED 500 SERIES STEEL IVORY WIREMOLD, FROM NEW LIGHT FIXTURE TO NEW GFI OUTLET. TERMINATE NEW WIRING TO EXISTING LIGHTING SWITCHLEG. PROVIDE ALL NECESSARY HARDWARE AND ALL FINAL TERMINATIONS.
- 6 REMOVE EXISTING WALL MOUNTED 18" LINEAR FLUORESCENT AND REPLACE WITH NEW MERCURY LIGHTING #MF38-WW-217-AFW-ELB-HP-UNI. PROVIDE ALL NECESSARY HARDWARE AND ALL FINAL TERMINATIONS.

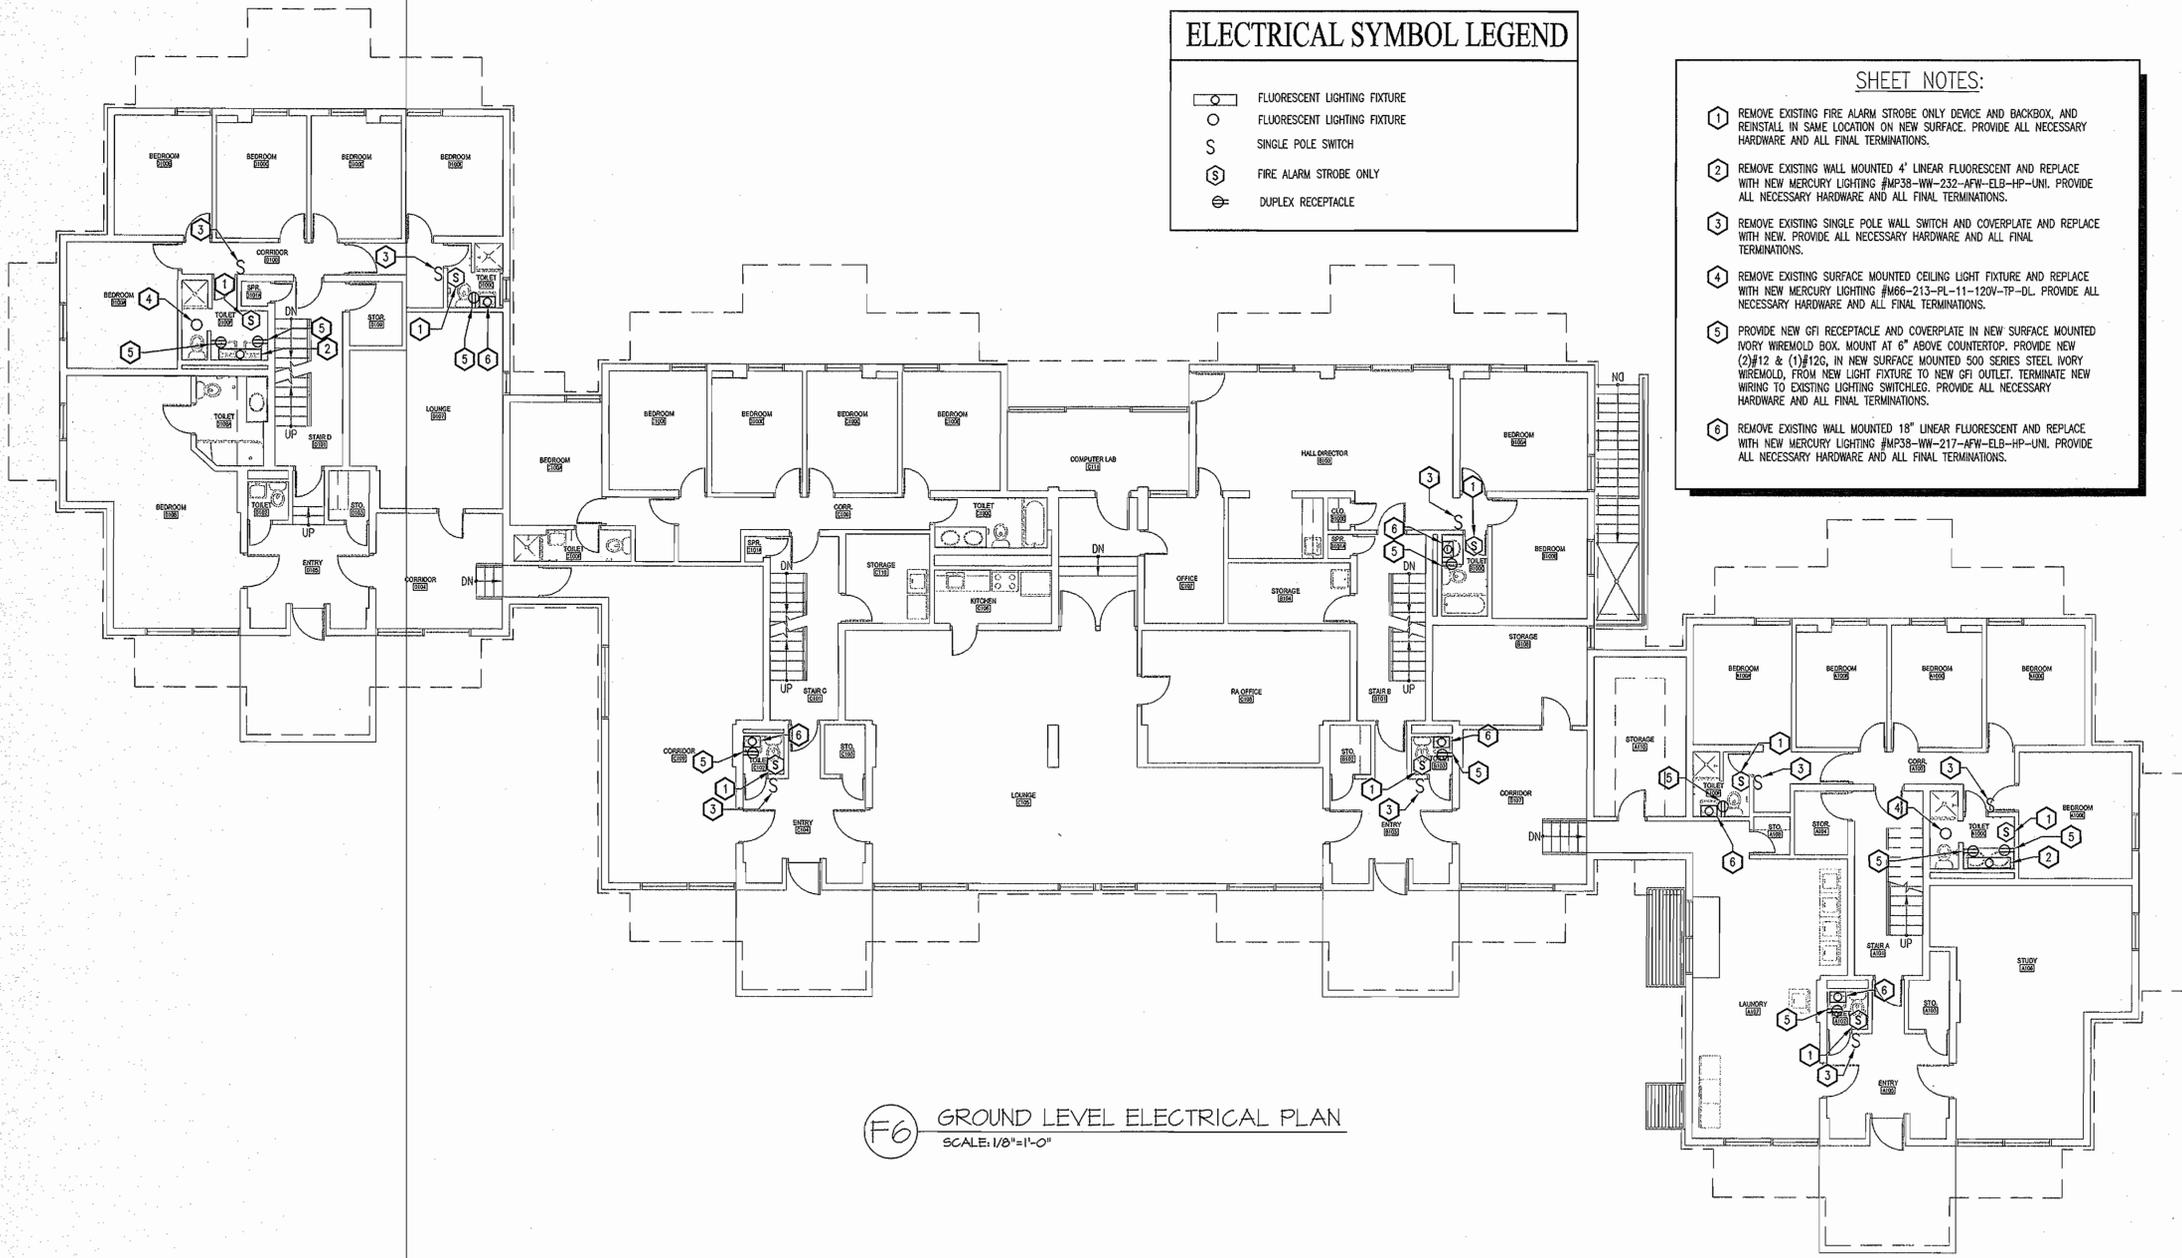

**F6 GROUND LEVEL ELECTRICAL PLAN**  
 SCALE: 1/8"=1'-0"

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10 | 9 | 8 | 7 | 6 | 5 | 4 | 3 | 2 | 1

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Project  
**University of Rhode Island DORR HALL BATHROOM RENOVATIONS & DOOR & SIGNAGE REPLACEMENT**  
 KINGSTON, RI



Seals



ISSUES

Date	Description
12/20/2012	CONSTRUCTION DOCUMENTS

Revisions


No.	Date	Description

Drawing Title  
**SECOND THRU FOURTH LEVEL ELECTRICAL PLAN**

Issue Date: 12/20/2012

Project No: UR1181N	Scale: AS NOTED
Project Manager: WMS	Production Leader: WMS
Project Architect:	Peer Reviewer: PDS

Drawing Number  
**E2.102**

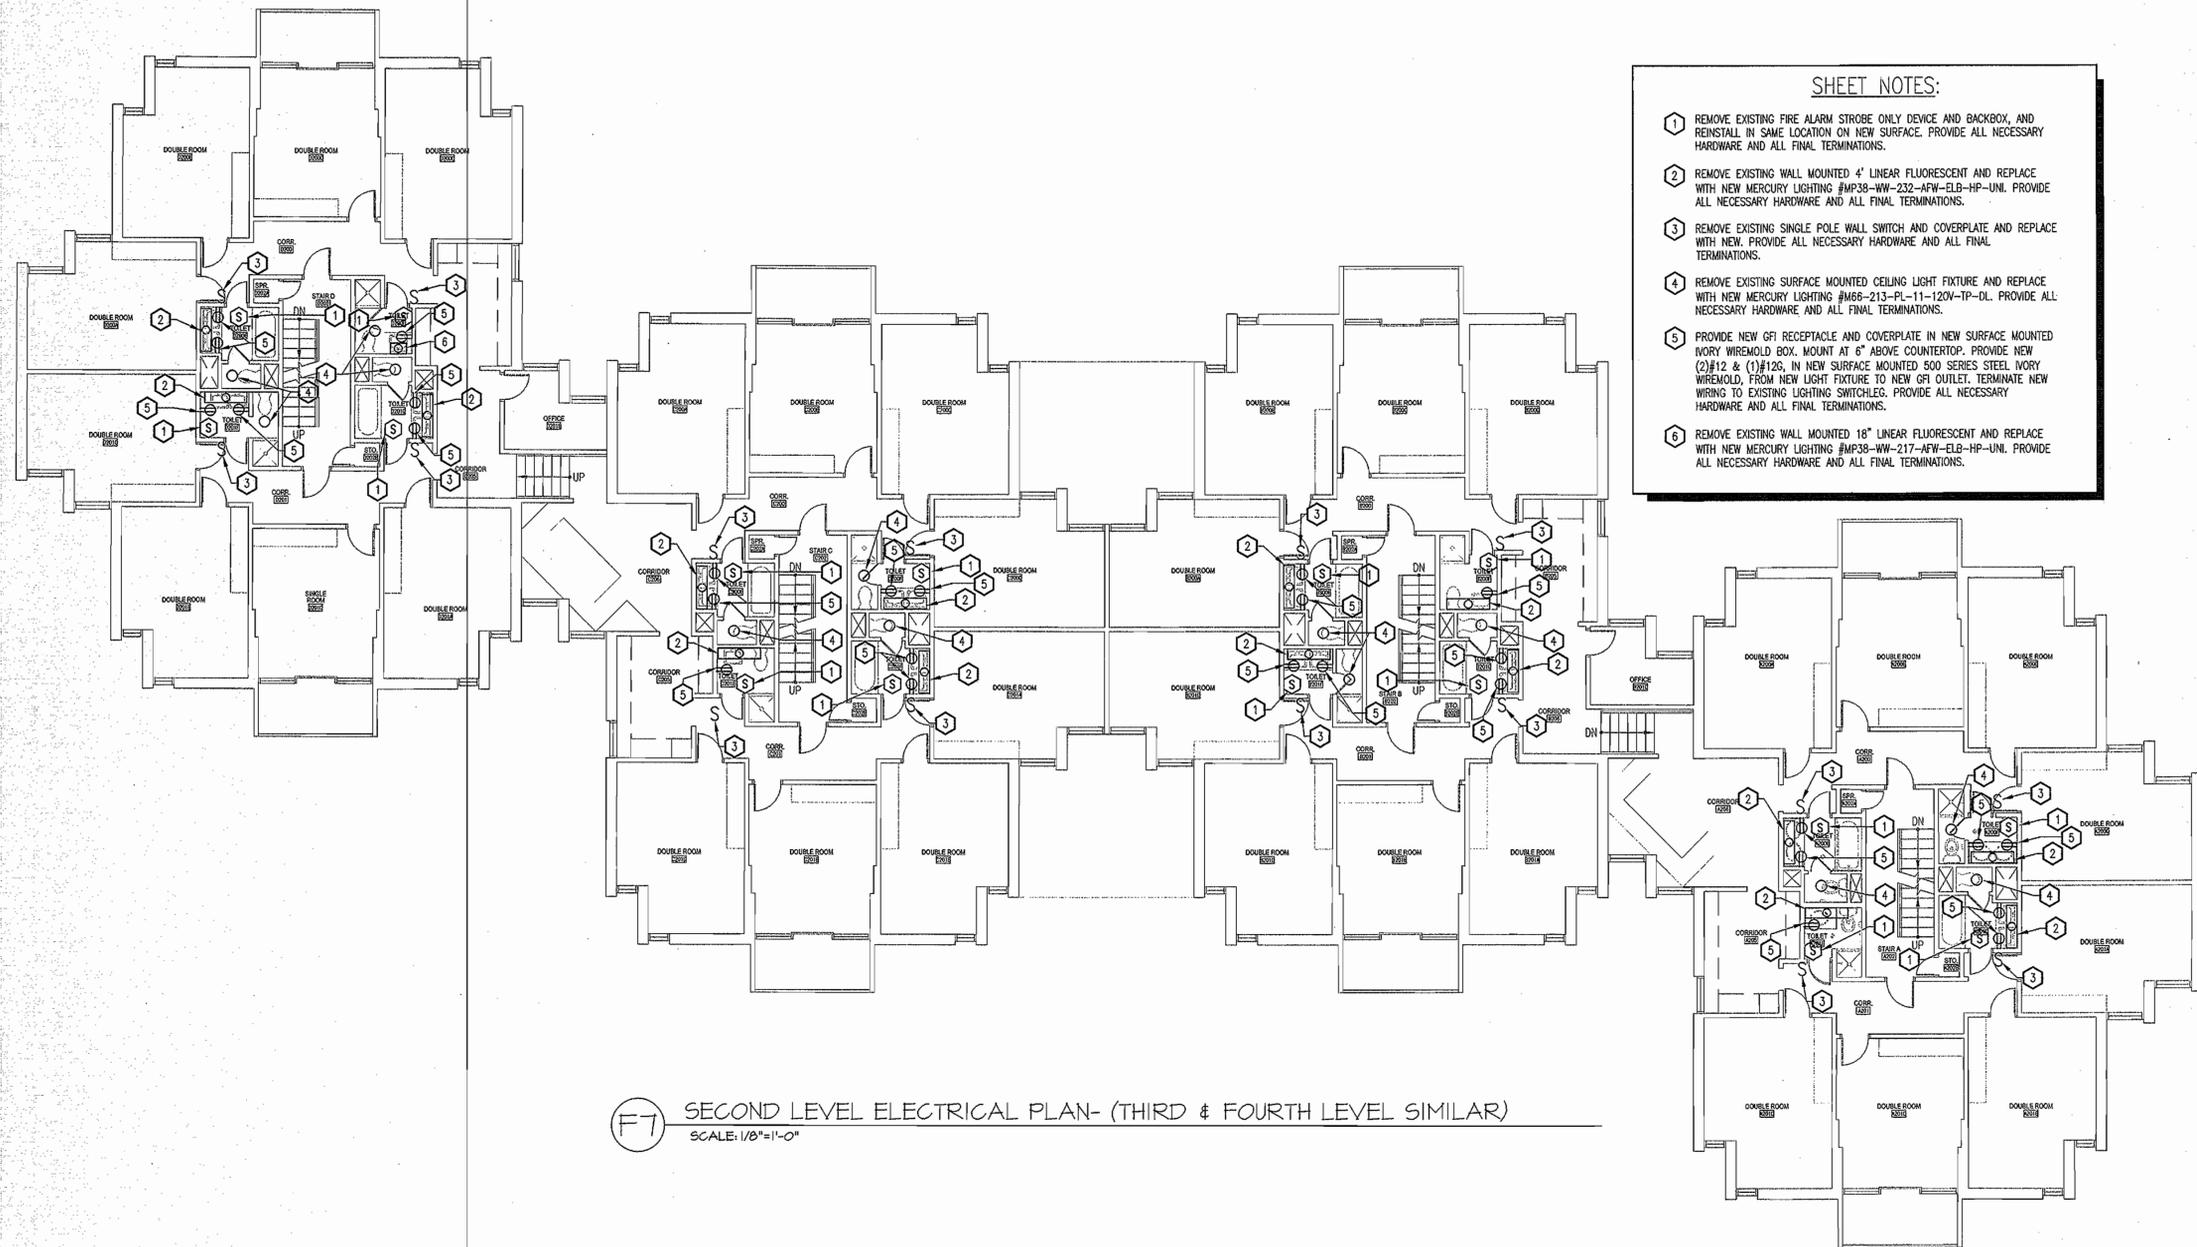

- SHEET NOTES:**
- 1 REMOVE EXISTING FIRE ALARM STROBE ONLY DEVICE AND BACKBOX, AND REINSTALL IN SAME LOCATION ON NEW SURFACE. PROVIDE ALL NECESSARY HARDWARE AND ALL FINAL TERMINATIONS.
  - 2 REMOVE EXISTING WALL MOUNTED 4' LINEAR FLUORESCENT AND REPLACE WITH NEW MERCURY LIGHTING #MP38-WW-232-AFW-ELB-HP-UNI. PROVIDE ALL NECESSARY HARDWARE AND ALL FINAL TERMINATIONS.
  - 3 REMOVE EXISTING SINGLE POLE WALL SWITCH AND COVERPLATE AND REPLACE WITH NEW. PROVIDE ALL NECESSARY HARDWARE AND ALL FINAL TERMINATIONS.
  - 4 REMOVE EXISTING SURFACE MOUNTED CEILING LIGHT FIXTURE AND REPLACE WITH NEW MERCURY LIGHTING #M66-213-PL-11-120V-TP-DL. PROVIDE ALL NECESSARY HARDWARE AND ALL FINAL TERMINATIONS.
  - 5 PROVIDE NEW GFI RECEPTACLE AND COVERPLATE IN NEW SURFACE MOUNTED IVORY WIREMOLD BOX. MOUNT AT 6" ABOVE COUNTERTOP. PROVIDE NEW (2)#12 & (1)#12G, IN NEW SURFACE MOUNTED 500 SERIES STEEL IVORY WIREMOLD, FROM NEW LIGHT FIXTURE TO NEW GFI OUTLET. TERMINATE NEW WIRING TO EXISTING LIGHTING SWITCH/LEG. PROVIDE ALL NECESSARY HARDWARE AND ALL FINAL TERMINATIONS.
  - 6 REMOVE EXISTING WALL MOUNTED 18" LINEAR FLUORESCENT AND REPLACE WITH NEW MERCURY LIGHTING #MP38-WW-217-AFW-ELB-HP-UNI. PROVIDE ALL NECESSARY HARDWARE AND ALL FINAL TERMINATIONS.

**F7** SECOND LEVEL ELECTRICAL PLAN- (THIRD & FOURTH LEVEL SIMILAR)  
 SCALE: 1/8"=1'-0"



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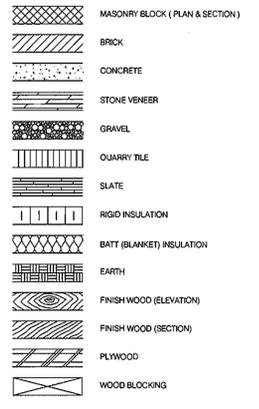
**ABBREVIATIONS**

AB ANCHOR BOLT	ACI AMERICAN CONCRETE INSTITUTE	ACOUST AC	ADJ ADJUSTABLE	AF ABOVE FINISH FLOOR	ALT ALTERNATE	ALUM ALUMINUM	ANCH ANCHOR	ARCH ARCHITECT	ASTM AMERICAN SOCIETY FOR TESTING MATERIALS	BL BUILDING LINE	BDC BOTTOM OF CURB	BD BOARD	BIT BITUMENOUS	BLDG BUILDING	BLK BLOCK	BLKG BLOCING	BM BEAM	BOF BOTTOM OF FOOTING ELEVATION	BOT BOTTOM	BRG BEARING	BRK BRICK	BTW BETWEEN	BUR BUILT UP ROOF	C CENTER LINE	CAB CABINET	CB CATCH BASIN	CCR CERAMIC	CI CAST IRON	CJ CONTROL JOINT	CLD CLOSURE	CTR CENTER	CLG CLOSURE CATCH BASIN	CLR CLEAR	CLM CLEAR (DIMENSION)	CM CONTRACT MANAGER	CMU CONCRETE MASONRY UNIT	CO CLEAN OUT	COL COLUMN	COMP COMPACTED (COMPOSITION)	CONSTR CONSTRUCTION	CONTR CONTRACTOR	CONTR CONTROL PANEL	CSG CASING	CSMT CASING	CT CERAMIC TILE	CY CUBIC YARD	DF DRINKING FOUNTAIN	DIA DIAMETER	DIAG DIAGONAL	DIM DIMENSION	DL DEAD LOAD	DN DOWN	DR DOOR	DS/C DRIVE SIDE OF CURB	DWG DETAIL DRAWING	E EAST	EJ EXPANSION JOINT	ELEV ELEVATION	ELC ELECTRICAL	ELEV ELEVATION	EQU EQUIPMENT	ER EMERGENCY ROOM	EST ESTIMATE	EW EACH WAY	EWC ELECTRIC WATER COOLER	EXH EXHAUST	EXIST EXISTING	EXP EXPANSION	EXPD EXPANDED	EXT EXTERIOR	FA FRESH AIR	FAP FIRE ALARM PANEL	FD FLOOR DRAIN	FDN FOUNDATION	FE FIRE EXTINGUISHER	FEC FIRE EXTINGUISHER CABINET	FHC FIRE HOSE CABINET	FIN FINISH	FL FLOOR LINE	FUR FLOOR	FOF FACE OF FINISH	FFM FACE OF FOUNDATION WALL	FFM FACE OF MASONRY	FOS FACE OF STUD	FR FIRE RATED	FS FULL SIZE	FOOT FOOT	FTG FOOTING	FUR FURRED (ING)	GA GAUZE	GALV GALVANIZED	GC GENERAL CONTRACTOR	GEN GENERAL	GLZ GLAZE	GRD GRADE	GUP GYPSUM	HC HANDICAP	HGT HEIGHT	HM HOLLOW METAL	HP HIGH POINT	HDWD HARDWOOD	HV HEATING & VENTILATING	HVH HOT WATER HEATER	HVAC HEATING, VENTILATING AND AIR CONDITIONING	ID INSIDE DIAMETER	IN INCH	INSUL INSULATION	INT INTERIOR	INV INVERT	JAN JANITOR	JST JOIST	JOINT JOINT	LAM LAMINATE	LAV LAVATORY	MAS MASONRY	MAT MATERIAL	MAX MAXIMUM	MECH MECHANICAL	MEM MEMBRANE	MEP MECHANICAL ELECTRICAL PLUMBING	METP METAL TOILET PARTITION	MFR MANUFACTURER	MTL METAL	MN MANHOLE	MM MINIMUM	MISC MISCELLANEOUS	MO MASONRY OPENING	MULL MULLION	N NORTH	NAT NATURAL	ND NAPKIN DISPENSER	NEC NECESSARY	NIC NOT IN CONTRACT	NOM NOMINAL	NRC NOISE REDUCTION COEFFICIENT	NTS NOT TO SCALE	OC ON CENTER	OD OUTSIDE DIAMETER	OF/C OUTSIDE FACE OF CONCRETE	OH OVERHEAD	OPG OPENING	OPP OPPOSITE	OR OPENING ROOM	PL PROPERTY LINE	PRD PARTIOL BOARD	PCF POUNDS PER CUBIC FOOT	PLAM PLASTIC LAMINATE	PLAS PLASTER	PNI PAIN	PSI POUNDS PER SQUARE INCH	PT PAINT	PTD PAINTED	PTH PARTITION	PVC POLYVINYL CHLORIDE	PLYWD PLYWOOD	QT QUARRY TILE	R RADIUS OR RISER	RA RETURN AIR	RC REINFORCED CONCRETE	RD ROOF DRAIN	REF REFERENCE	REFR REFRIGERATOR	RENF REINFORCE	REQD REQUIRED	RGH ROUGH	RL RAIN LEADER	RM ROOM	ROOMT ROOM	RO REQUIREMENT	RO ROUGH OPENING	ROW RIGHT OF WAY	S SOUTH OR SINK	SC SOLID CORE	SCED SCHEDULE	SF SQUARE FOOT	SHR SHOWER OR SHELF	SHT SHEET	SIM SIM	SL SLIDING	SMR SINGLE PLY MEMBRANE ROOF	SP/FFR SPECIAL PAINT FINISH	SPEC SPECIFICATIONS	SPR SPREADER	SQ SQUARE	SSL STAINLESS STEEL	STA STATION	STD STANDARD	STL STEEL	STOR STORAGE	STRUCT STRUCTURAL	SUSP SUSPEND (ED)	SYST SYSTEM	T TREAD	TB TACKBOARD	TCOP TOP OF CURB	TBL TELEPHONE	TEMP TEMPERATURE OR TEMPORARY	TERR TERRAZZO	TFRM TOP OF FRAME	T&G TONGUE & GROOVED	THLD THRESHOLD	THK THICK	TLT TOILET	TR TO REMAIN	TYP TYPICAL	TOP TOP OF FOUNDATION	TOW TOP OF WALL ELEVATION	TOE TOP OF STEEL ELEVATION	TS&B TOP OF SLAB	UH UNIT HEATER	UL UNDERWRITERS LABORATORIES, INC.	UCD UNDERSIDE OF DECK	UCN UNLESS OTHERWISE NOTED	UR URINAL	UV UNIT VENTILATOR	V VARIES OR VARIABLE	VB VINYL BASE	VCT VINYL COMPOSITION TILE	VERT VERTICAL	VEST VESTIBULE	VFP VERIFY IN FIELD	VNR VENER	VOL VOLUME	W WEST OR WIDTH	W WITH	WC WATER CLOSET	WD WOOD	WDR WINDOW	WEL WIRE GLASS	WP WEATHERPROOF (WATERPROOFING)	WWF WELDED WIRE FABRIC
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**GRAPHIC SYMBOLS**



**MATERIAL SYMBOLS**

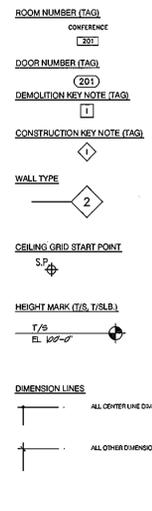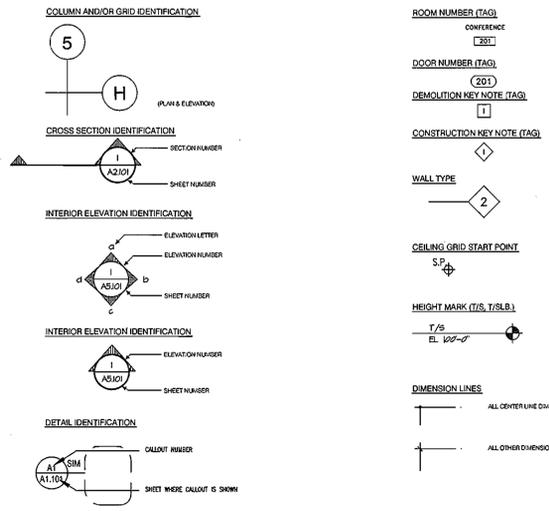

**APPLICABLE CODES**

- 2002 RHODE ISLAND STATE REHABILITATION BUILDING AND FIRE CODES FOR EXISTING BUILDINGS AND STRUCTURES.
- SBC-1 RHODE ISLAND STATE BUILDING CODE.
- SBC-3 RHODE ISLAND STATE PLUMBING CODE.
- SBC-4 RHODE ISLAND STATE MECHANICAL CODE.
- SBC-5 RHODE ISLAND STATE ELECTRICAL CODE.
- SBC-8 RHODE ISLAND STATE ENERGY CONSERVATION CODE.
- RHODE ISLAND FIRE SAFETY CODE.
- RHODE ISLAND FIRE PREVENTION CODE.
- NEPA 101.
- LIFE SAFETY CODE FOR EXISTING BUILDINGS.


**GENERAL BUILDING INFORMATION**

ELLERY RESIDENCE HALL BUILDING INFORMATION  
 OCCUPANCY USE: R2 - RESIDENTIAL DORMITORY  
 EXISTING CONSTRUCTION TYPE: IIA  
 FLOOR AREA: WRES 30,049 S.F.  
 TOTAL FLOOR AREA: 4 STORES AND BASEMENT  
 HEIGHT: FULLY SPRINKLERED  
 FIRE SUPPRESSION SYSTEM: YES  
 FIRE ALARM: YES  
 FIRE RATINGS: CORRIDOR WALLS 30 MIN.  
 BATHROOM DOORS 20 MIN.  
 ACCESSIBILITY: NO


**ALTERNATE BIDS**

- FLOOR DRAINS @ ALL BATHROOMS ON SECOND, THIRD & FOURTH FLOORS AS WELL AS @ ROOM NUMBERS B100E & B100F ON THE FIRST FLOOR
  - REPLACE ALL DOORS AT EXTERIOR; BEDROOMS, BATHROOMS, OFFICES AND STORAGE AS PER DOOR SCHEDULE.
- NOTE: REPLACEMENT OF BATHROOM DOORS IS PART OF BASE BID.

**MANEUVERING CLEARANCES FOR ALL DOORS**

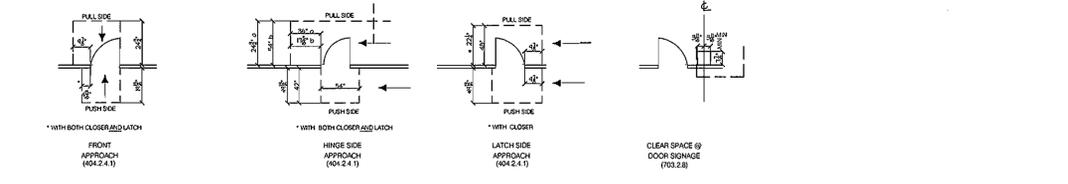


**FIXTURE HEIGHTS**

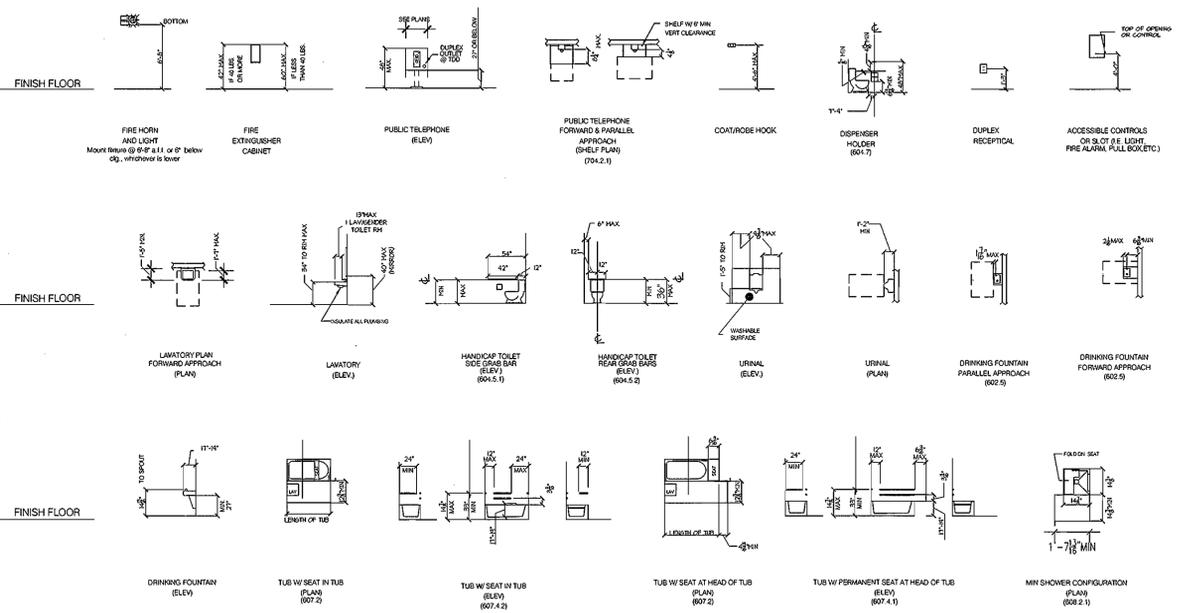

**DOOR HARDWARE INSTALLATION DIMENSIONS**

- ALL DIMENSIONS NOTED TO THE RIGHT ARE RECOMMENDED MANUFACTURERS STANDARDS THAT MEET ANSI AND ADA REQUIREMENTS.
- DIMENSIONS TO THE RIGHT ARE INDUSTRY STANDARDS. ANY CONFLICTS BETWEEN ARCHITECTURAL DETAILS WITH DOCUMENTS, AND INDUSTRY STANDARD DIMENSIONS ARE TO BE REVIEWED WITH ARCHITECT PRIOR TO HARDWARE INSTALLATION.
- ALL DIMENSIONS NOTED ARE TAKEN FROM FINISH FLOOR TO CENTER LINE OF DEVICE.
- PUSH PLATE - 45" TO CENTERLINE.
- DOOR PULL - 42" TO CENTERLINE.
- HINGS AND LEVERS - 36" TO 42" TO CENTERLINE OF DEVICE.
- HOSPITAL LATCHSET - 45 3/4" TO CENTERLINE OF LATCH BOLT.
- DEAD LOCK - 48" TO CENTERLINE.
- PANIC DEVICE - 42" TO CENTERLINE.

**KEY PLAN**

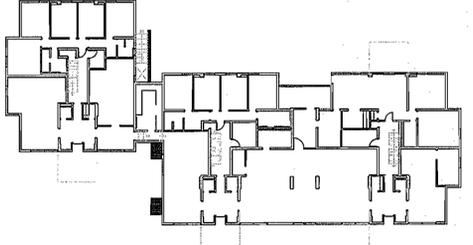


**TectonArchitects inc**  
 1 Hartford Sq. West, Hartford CT 06106  
 860 548 0802  
 17 Railroad Avenue, Westerly RI 02891  
 401 596 7555  
 tectonarchitects.com

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Consultant  
  
 Owner  
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**THINK BIG WE DO**

Project  
**University of Rhode Island  
 ELLERY HALL BATHROOM  
 RENOVATION & DOOR &  
 SIGNAGE REPLACEMENT  
 KINGSTON, RI**



Seals

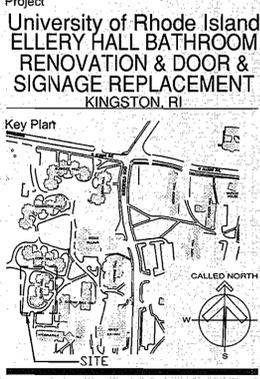Issues	Date	Description
	12/20/2012	FOR CONSTRUCTION


Revisions	No.	Date	Description
	1	12/08/2012	REVIEW

Drawing Title

**GENERAL INFORMATION**

Issue Date:	12/20/2012
Project No:	KC.R.ROGW. 2010.001
Project Manager:	MT Production Leader: MS
Project Architect:	MT Peer Reviewer: JM
Drawing Number:	

**G1.101**

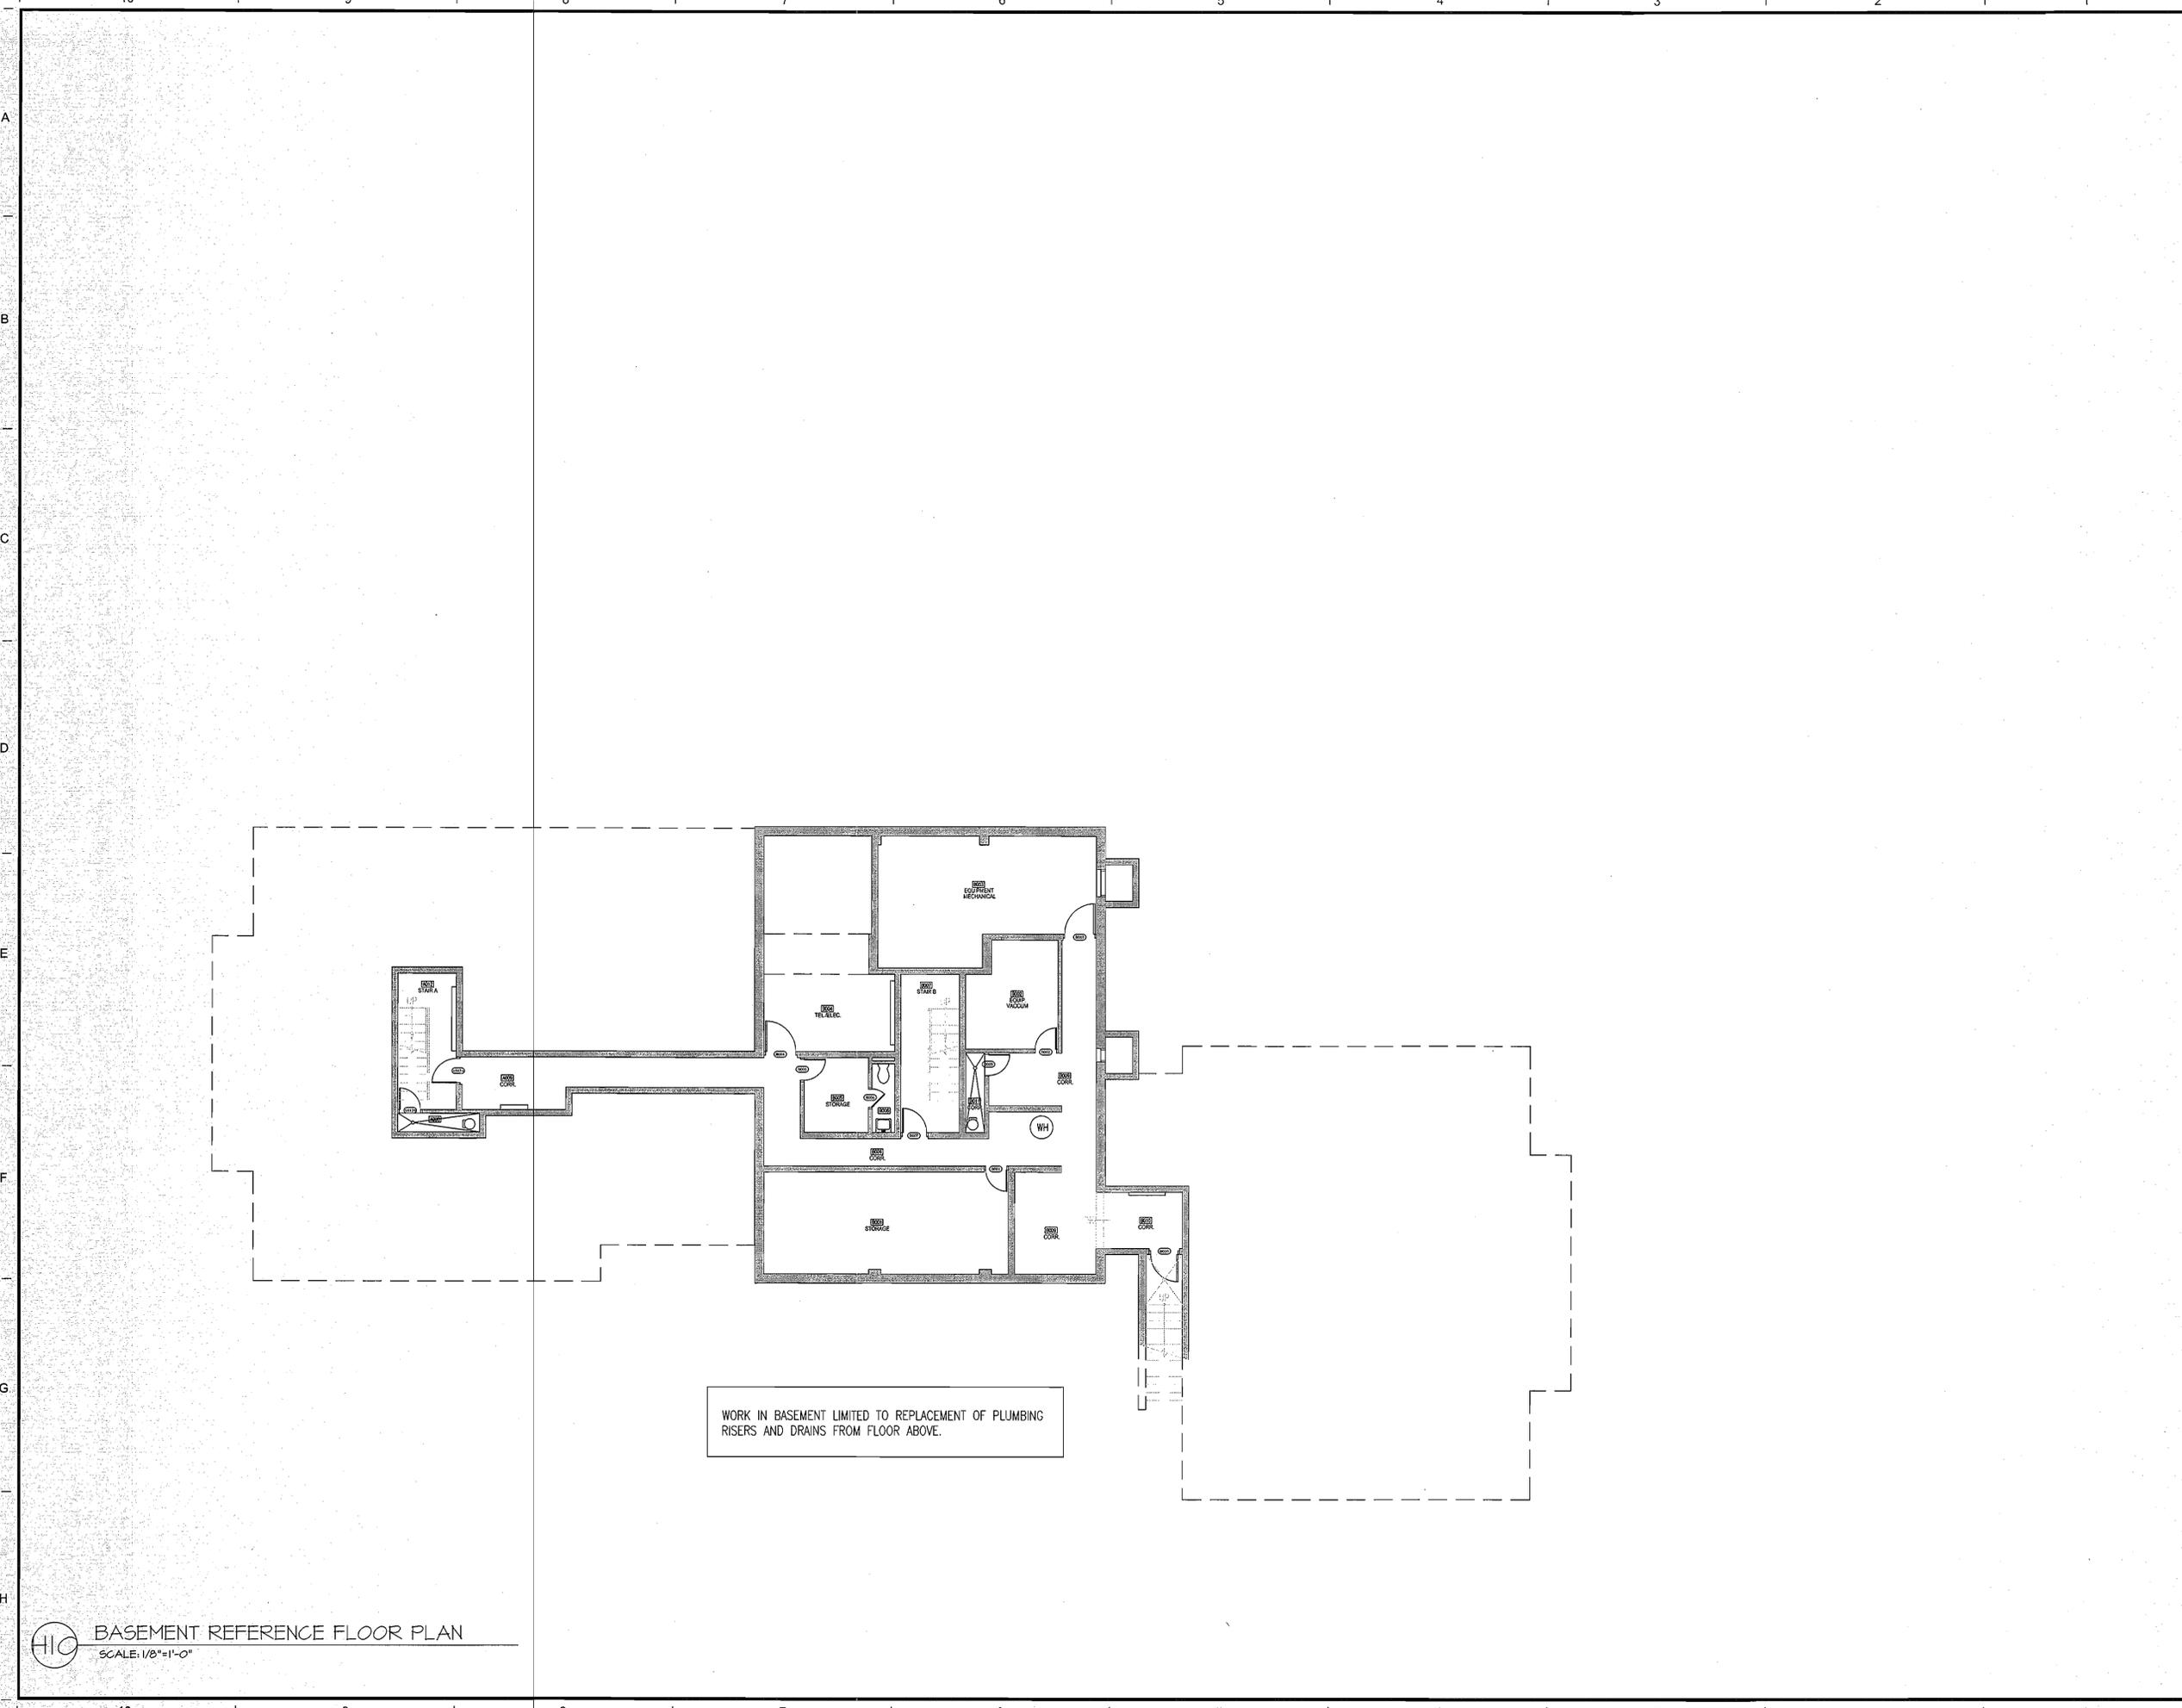

**HIC** BASEMENT REFERENCE FLOOR PLAN  
SCALE: 1/8"=1'-0"




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RENOVATION & DOOR &  
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KINGSTON, RI**



Issues

Date	Description
12/20/2012	FOR CONSTRUCTION

Revisions

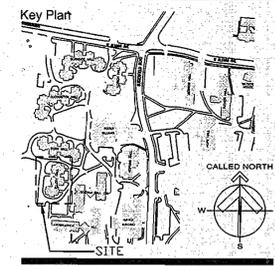
No.	Date	Description
1	12/05/2012	REVIEW

Drawing Title  
**REFERENCE & DOOR DEMOLITION FLOOR PLANS**


Issue Date: 12/20/2012

Project No:	KC-R-ROGW-2010-001	Scale:	AS NOTED
Project Manager:	MT	Production Leader:	MS
Project Architect:	MT	Peer Reviewer:	JM

Drawing Number  
**A2.100**

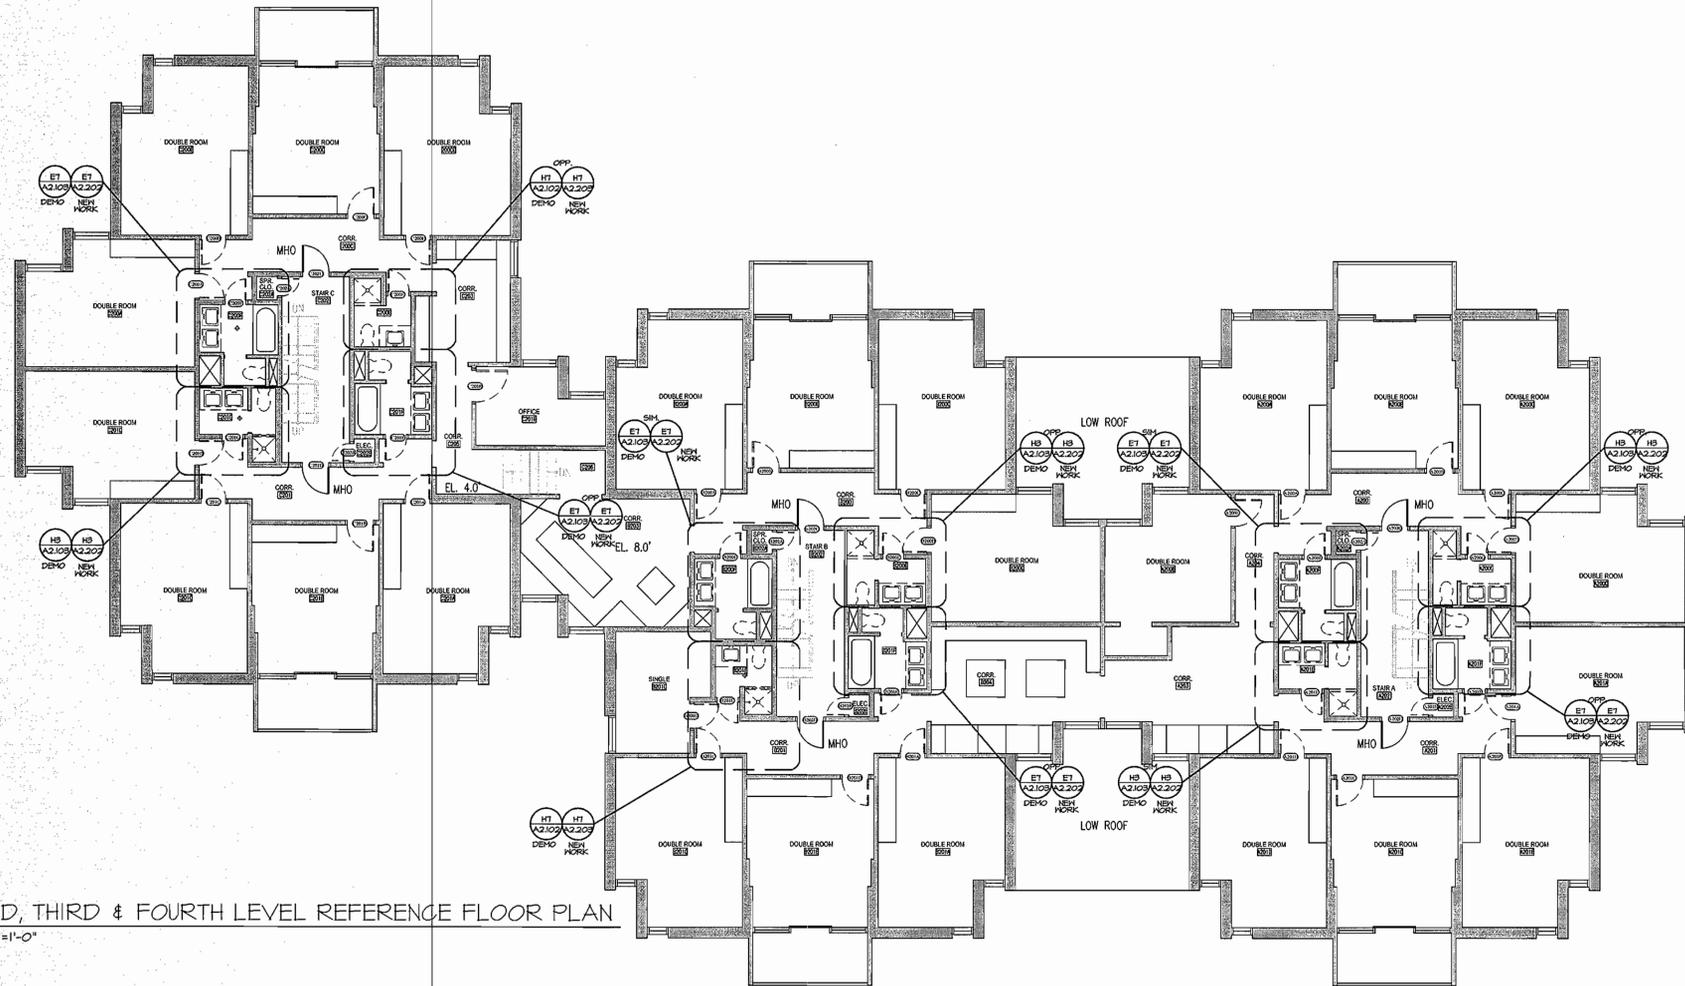

**D10** SECOND, THIRD & FOURTH LEVEL REFERENCE FLOOR PLAN  
SCALE: 1/8"=1'-0"

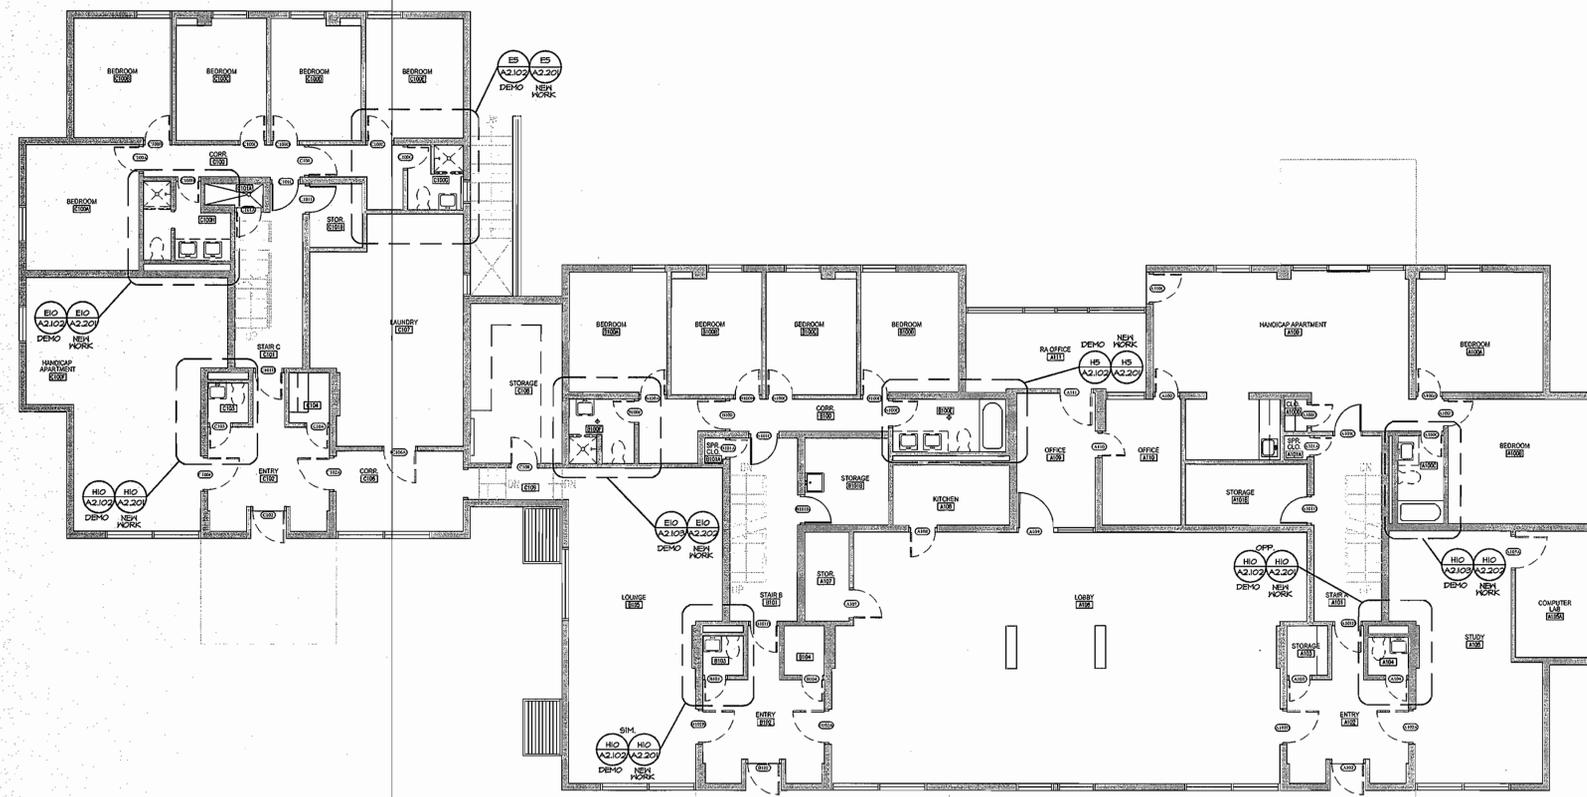

**H10** GROUND LEVEL REFERENCE FLOOR PLAN  
SCALE: 1/8"=1'-0"

**GENERAL DEMOLITION NOTES**

- COORDINATE ALL DEMOLITION WITH NEW CONSTRUCTION REQUIREMENTS
- THE CONTRACTOR SHALL BE RESPONSIBLE FOR THE REMOVAL & LAWFUL DISPOSAL OF ALL MATERIALS AS DESCRIBED.
- PROVIDE TEMPORARY SURFACE PROTECTION DURING REMOVAL OF ITEMS. CONTRACTOR IS RESPONSIBLE FOR ANY SURFACE/FLOOR/FINISH DAMAGE THAT MAY OCCUR.
- MECHANICAL, ELECTRICAL AND/OR OTHER WORK RELATED TO A WALL OR AREA SCHEDULED FOR DEMOLITION AND REMOVAL SHALL BE PERFORMED WHETHER SO NOTED OR NOT. PROTECT ALL ITEMS INTENDED FOR SALVAGE AND REUSE OR SCHEDULED TO REMAIN.
- WHERE DOORS AND TRANSOMS ARE SHOWN TO BE DEMOLISHED FRAMES ARE TO REMAIN. PATCH AND REPAIR ANY DAMAGE TO EXISTING DOOR FRAME AND PREPARE FOR INSTALLATION OF NEW DOOR AND TRANSOM. COORDINATE WITH DOOR SCHEDULE.
- REMOVE EXISTING WALL TILE IN BATHROOM.
- REMOVE AND DISPOSE OF ALL EXISTING BATHROOM CEILING.
- REMOVE AND DISPOSE OF RUBBER COVE AT ALL BATHROOM WALLS AND BATHUB SKIRTS.

**DEMOLITION LEGEND**




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Project  
**University of Rhode Island ELLERY HALL BATHROOM RENOVATION & DOOR & SIGNAGE REPLACEMENT KINGSTON, RI**



Issues

Date	Description
12/20/2012	FOR CONSTRUCTION

Revisions

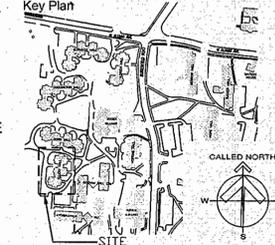
No.	Date	Description
1	12/05/2012	REVIEW

Drawing Title  
**REFERENCE & DOOR DEMOLITION FLOOR PLANS**


Issue Date: 12/20/2012  
Project No: KC-R-ROGW-2010-001 Scale: AS NOTED  
Project Manager: MT Production Leader: MS  
Project Architect: MT Peer Reviewer: JM  
Drawing Number

**A2.101**


A  
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**E10** BATHROOM DEMOLITION PLAN - (C100H)  
SCALE: 1/2" = 1'-0"

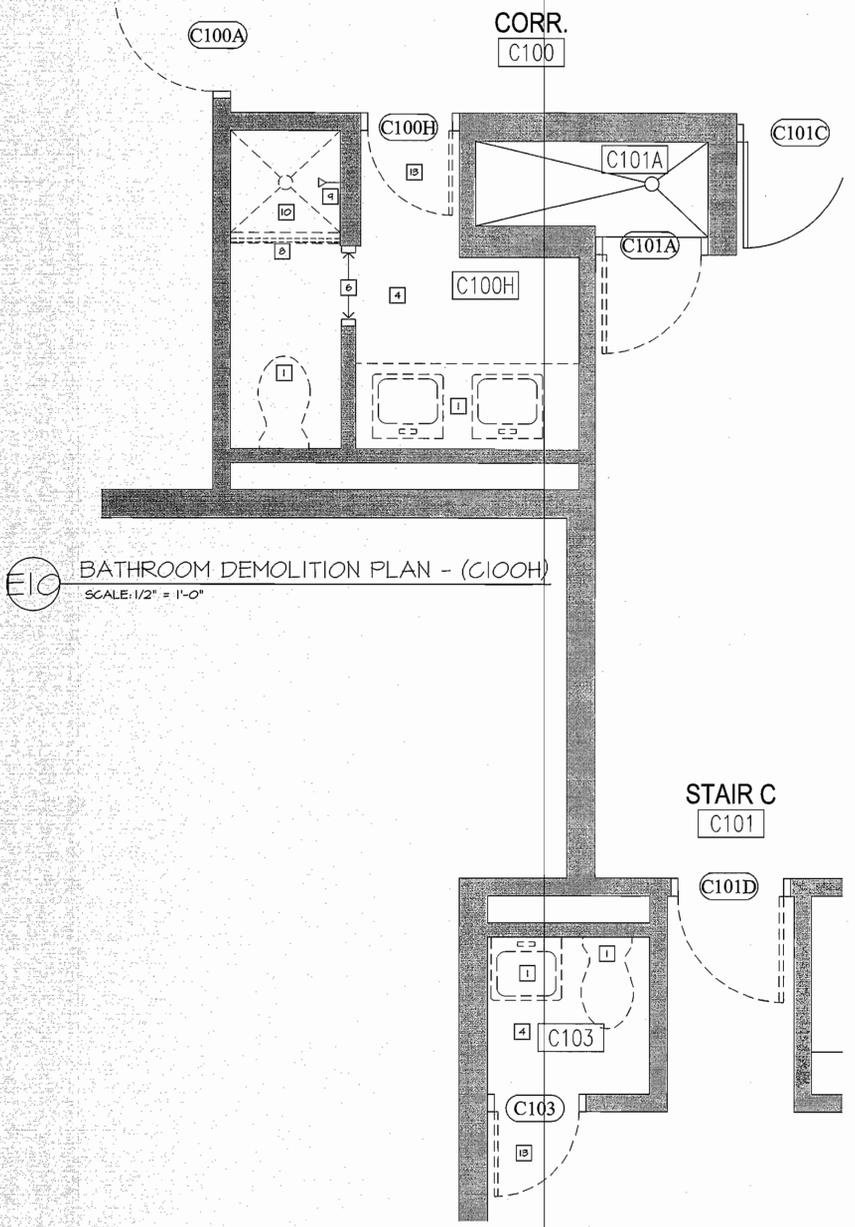

**E5** BATHROOM DEMOLITION PLAN - (C100G)  
SCALE: 1/2" = 1'-0"

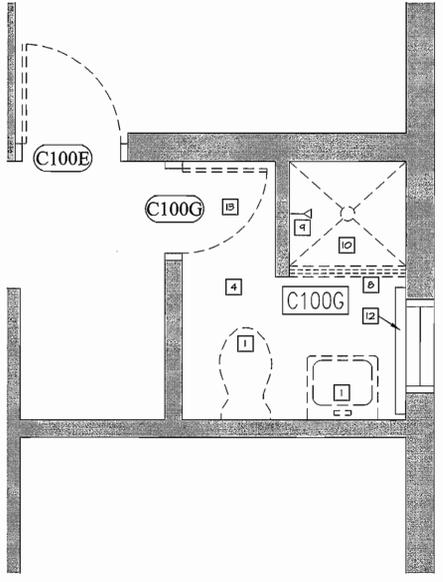

**H5** BATHROOM DEMOLITION PLAN - (B100E)  
SCALE: 1/2" = 1'-0"

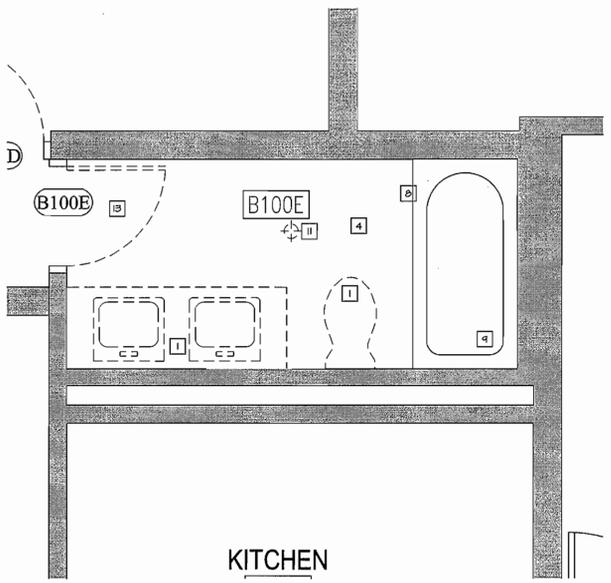**H10** BATHROOM DEMOLITION PLAN - (A104, B103, C103)  
SCALE: 1/2" = 1'-0"


**GENERAL DEMOLITION NOTES**

1. COORDINATE ALL DEMOLITION WITH NEW CONSTRUCTION REQUIREMENTS
2. THE CONTRACTOR SHALL BE RESPONSIBLE FOR THE REMOVAL & LAWFUL DISPOSING OF ALL MATERIALS AS DESCRIBED.
3. PROVIDE TEMPORARY SURFACE PROTECTION DURING REMOVAL OF ITEMS. CONTRACTOR IS RESPONSIBLE FOR ANY SURFACE/FLOOR/FINISH DAMAGE THAT MAY OCCUR.
4. MECHANICAL, ELECTRICAL AND OR OTHER WORK RELATED TO A WALL OR AREA SCHEDULED FOR DEMOLITION AND REMOVAL SHALL BE PERFORMED WHETHER SO NOTED OR NOT. PROTECT ALL ITEMS INTENDED FOR SALVAGE AND REUSE OR SCHEDULED TO REMAIN.
5. WHERE DOORS AND TRANSOMS ARE SHOWN TO BE DEMOLISHED FRAMES ARE TO REMAIN. PATCH AND REPAIR ANY DAMAGE TO EXISTING DOOR FRAME AND PREPARE FOR INSTALLATION OF NEW DOOR. COORDINATE WITH DOOR SCHEDULE.
6. REMOVE EXISTING WALL TILE IN BATHUB STALL.
7. REMOVE AND DISPOSE OF ALL EXISTING BATHROOM CEILING.

**DEMOLITION KEY NOTES**

- 1 REMOVE & DISPOSE OF EXISTING TOILETS, LAVATORIES, FAUCETS, COUNTERS AND CABINETS.
- 2 REMOVE AND RELOCATE EXISTING LIGHT SWITCH AS REQUIRED. REFER TO (E) DRAWINGS.
- 3 REMOVE EXHAUST GRILLE IN CEILING. CLEAN AND VACUUM EXHAUST DUCT. CLEAN & STORE EXHAUST GRILL FOR REINSTALLATION WITH NEW CEILING.
- 4 SANDBLAST PAINTED CONCRETE FLOOR & PREPARE FOR NEW FLOOR INSTALLATION.
- 5 REMOVE & DISPOSE OF EXISTING LIGHT FIXTURES.
- 6 REMOVE & DISPOSE OF EXISTING DOOR FRAMES @ WATER CLOSET FRAMED OPENINGS. SECURE & PREPARE WALL FOR NEW FRAMED OPENING. PATCH PLASTER SMOOTH FINISH AT OPENING PERIMETER.
- 7 REMOVE & DISPOSE OF EXISTING TOWEL BARS, TOILET PAPER DISPENSER AND MIRRORS. PATCH HOLES IN WALL.
- 8 REMOVE & DISPOSE OF EXISTING SHOWER ROD AND CURTAIN.
- 9 REMOVE & DISPOSE OF EXISTING SHOWER VALVES, DRAINS & SHOWERHEADS. NOTE: WORK TO BE PERFORMED BY BATHTITERS
- 10 REMOVE & DISPOSE OF EXISTING FIBERGLASS SHOWER BASIN. NOTE: WORK TO BE PERFORMED BY BATHTITERS
- 11 (ALTERNATE #1) CORE DRILL EXISTING CONCRETE SLAB TO PREPARE FOR NEW FLOOR DRAIN. COORDINATE SIZE AND LOCATION WITH P-DRAWINGS AND FINISHES.
- 12 REMOVE AND SALVAGE HEATER CABINET ENDS AND COVERS FOR REINSTALLATION. NOTE: APPLIES TO BATHROOM #C100G & ALL OF FOURTH FLOOR BATHROOMS.
- 13 (BASE B0) REMOVE EXISTING DOOR, HINGES AND TRANSOM PANEL FROM FRAME. PREPARE FOR INSTALLATION OF NEW TRANSOM PANEL, DOOR AND DOOR HARDWARE AS PER SCHEDULE.

**DEMOLITION LEGEND**

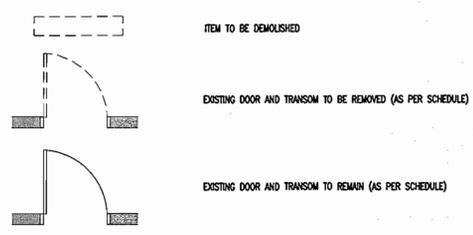

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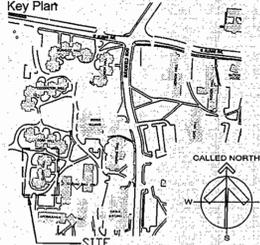


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**University of Rhode Island  
ELLERY HALL BATHROOM  
RENOVATION & DOOR &  
SIGNAGE REPLACEMENT  
KINGSTON, RI**



Issues	Date	Description
	12/20/2012	FOR CONSTRUCTION

Revisions	No.	Date	Description
	1	12/05/2012	REVIEW


Drawing Title  
**ENLARGED  
BATHROOM  
DEMOLITION  
FLOOR PLANS**

Issue Date:	12/20/2012
Project No:	KC.P. ROOM 2010.001
Scale:	AS NOTED
Project Manager:	MT
Production Leader:	MS
Project Architect:	MT
Peer Reviewer:	JM


Drawing Number  
**A2.102**

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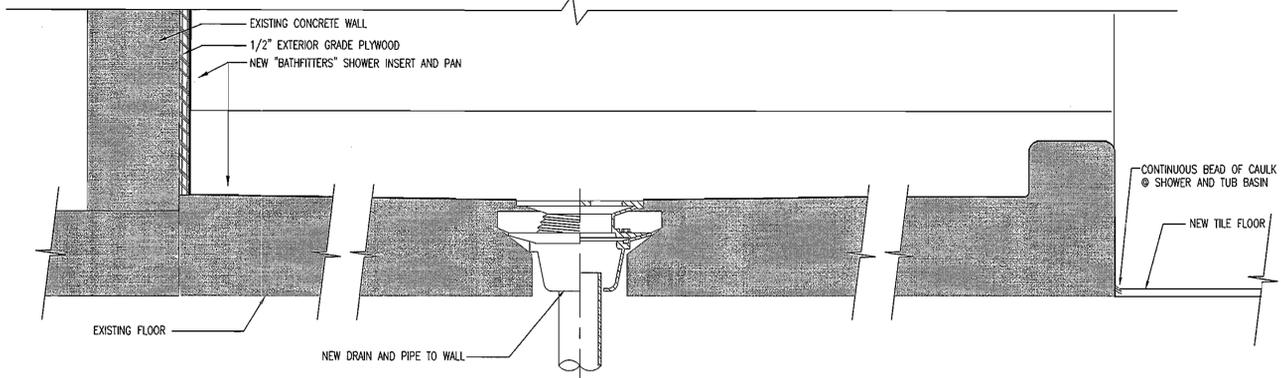


**B10** F.R.P. END PANEL @ BATHFITTERS SHOWER ENCLOSURE  
SCALE: 6" = 1'-0"

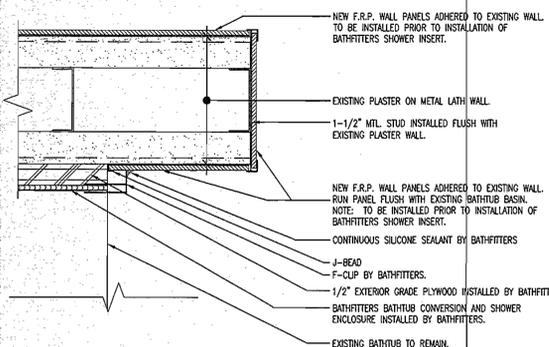


**E10** BATHROOM FLOOR PLAN  
SCALE: 1/2" = 1'-0"

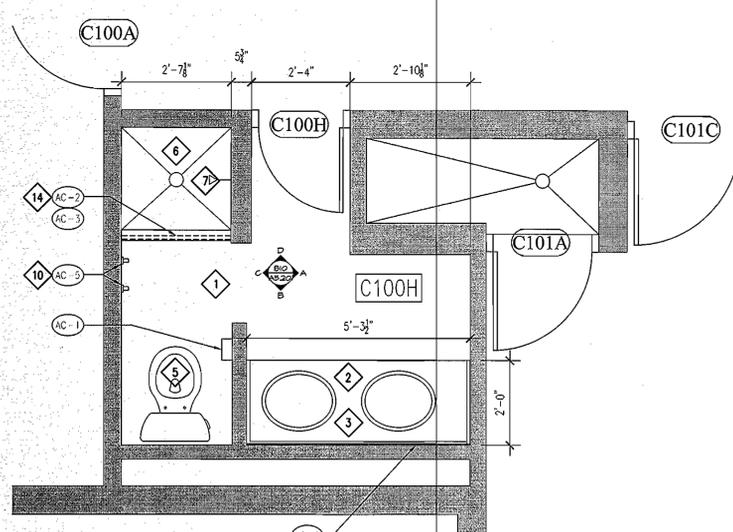
**H10** BATHROOM FLOOR PLAN  
SCALE: 1/2" = 1'-0"



**B7** SHOWER DRAIN DETAIL  
SCALE: 3" = 1'-0"

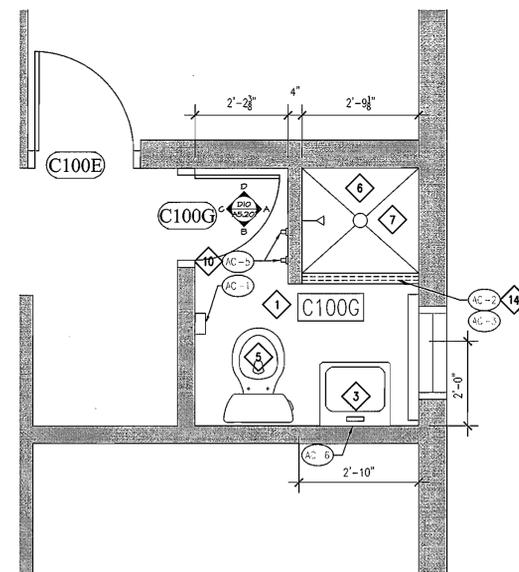

**E5** BATHROOM FLOOR PLAN  
SCALE: 1/2" = 1'-0"

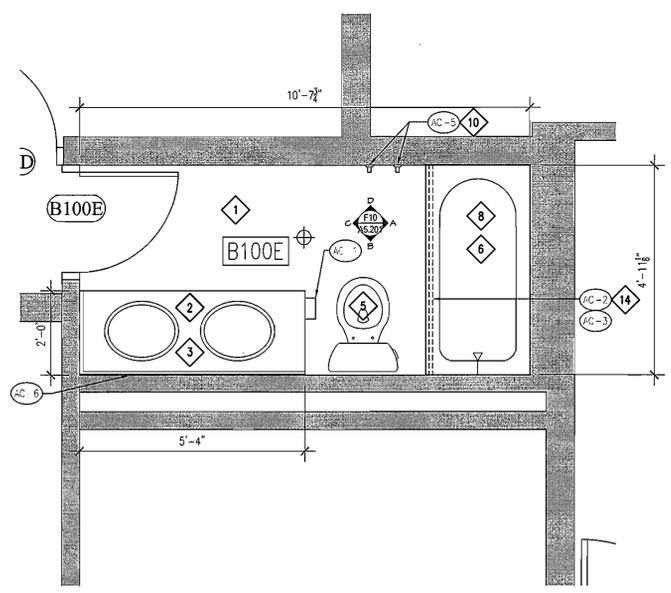

**H5** BATHROOM FLOOR PLAN  
SCALE: 1/2" = 1'-0"

**CONSTRUCTION NOTES**

- 1 PREPARE SUBFLOOR AND INSTALL NEW 2X2 CERAMIC TILE FLOORING & COVE.
- 2 INSTALL NEW SOLID SURFACE COUNTER, BACK SPLASH, SIDE SPLASH AND INTEGRAL SINKS. CONNECT TO EXISTING SUPPLY AND DRAIN.
- 2A INSTALL NEW WALL MOUNTED SINK CONNECT TO EXISTING SUPPLY AND DRAIN.
- 3 INSTALL NEW FAUCETS AND VALVES.
- 4 INSTALL FIBER REINFORCED PANELS FLOOR TO UNDERSIDE OF DECK ON ALL BATHROOM WALLS (EXCEPT @ SHOWER & BATHTUB STALLS - SEE ALSO DETAIL B10/A2.201).
- 5 INSTALL NEW TOILET AND RECONNECT TO SUPPLY AND DRAIN.
- 6 INSTALL NEW BATHFITTERS DRAIN, VALVE AND SHOWERHEAD. (WORK TO BE PERFORMED BY BATHFITTERS).
- 7 INSTALL NEW BATHFITTERS SHOWER ENCLOSURES INCLUDING SHOWER PAN, WALL INSERTS & CEILING. (WORK TO BE PERFORMED BY BATHFITTERS).
- 8 INSTALL NEW BATHFITTERS BATHTUB LINER & WALL INSERTS. (WORK TO BE PERFORMED BY BATHFITTERS).
- 9 INSTALL NEW DRAIN. (WORK TO BE PERFORMED BY BATHFITTERS).
- 10 INSTALL NEW STAINLESS STEEL ROBE HOOKS @ 6'-0" AFF. REFER TO INTERIOR ELEVATIONS - AS.201/AS.202 FOR LOCATIONS.
- 11 PROVIDE AND INSTALL ONE WALL MOUNTED UP/DOWN FLUORESCENT LIGHT FIXTURE ABOVE SINK AND ONE CEILING MOUNTED LIGHT FIXTURE IN FRONT OF SHOWER (SEE REFLECTED CEILING PLAN). INSTALLATION INCLUDES WIREMOLD, WIRE AND SWITCH.
- 12 FURNISH AND INSTALL ONE 16" DEEP HEAVY DUTY, PLASTIC COATED METAL WIRE SHELF SET 8" A.F.F.
- 13 REINSTALL EXHAUST GRILLE IN CEILING.
- 14 INSTALL NEW SHOWER ROD AND CURTAIN AT EXISTING HEIGHT.
- 15 INSTALL ACCESS PANELS, REPLACE DAMAGED UNITS. (CONTINGENCY ALLOWANCE)
- 16 INSTALL NEW DOOR AND TRANSOM AS PER SCHEDULE. PATCH AND REPAIR EXISTING DOOR FRAME AND PAINT.

**TOILET ACCESSORIES**

- AC-1 TOILET PAPER HOLDER. TO BE PROVIDED BY OWNER AND INSTALLED BY CONTRACTOR.
- AC-2 STAINLESS STEEL, SATIN FINISH SHOWER ROD & MOUNTING BRACKETS.
- AC-3 SHOWER CURTAIN AND SHOWER CURTAIN RINGS
- AC-4 NEW HEAVY DUTY METAL WIRE SHELF - MOUNTED 8" A.F.F.
- AC-5 NEW STAINLESS STEEL ROBE HOOKS MTD. 6'-0" A.F.F.
- AC-6 NEW FRAMELESS MIRROR - REFER TO INTERIOR ELEVATIONS - AS.201/5.202 FOR SIZING.
- AC-7 8" DEEP SOLID SURFACE PLASTIC SHELF.

**NOTE:**  
1. BATHFITTERS INSTALLATION TO BE DONE LAST.




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Project  
**University of Rhode Island  
ELLERY HALL BATHROOM  
RENOVATION & DOOR &  
SIGNAGE REPLACEMENT  
KINGSTON, RI**



Issues

Date	Description
12/20/2012	FOR CONSTRUCTION

Revisions

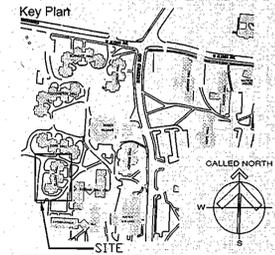
No.	Date	Description
1	12/05/2012	REVIEW

Drawing Title


**BATHROOM  
CONSTRUCTION  
FLOOR PLANS**

Issue Date: 12/20/2012  
Project No: KC.F.RCGW.2010.001 Scale: AS NOTED  
Project Manager: MT Production Leader: MS  
Project Architect: MT Peer Reviewer: JM  
Drawing Number


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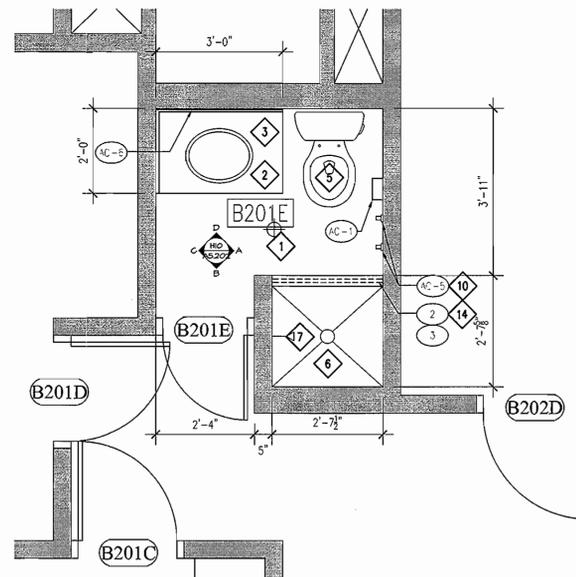
**D1C** BATHROOM FLOOR PLAN  
SCALE: 1/2" = 1'-0"

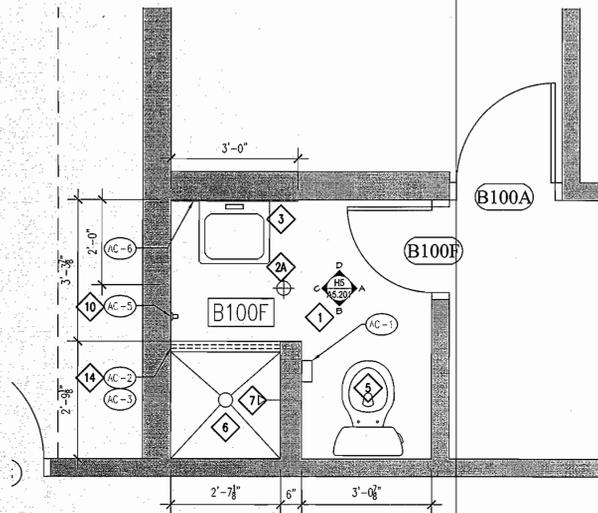


**D7** BATHROOM FLOOR PLAN (TYPICAL @ 2ND, 3RD & 4TH FLOOR)  
SCALE: 1/2" = 1'-0"

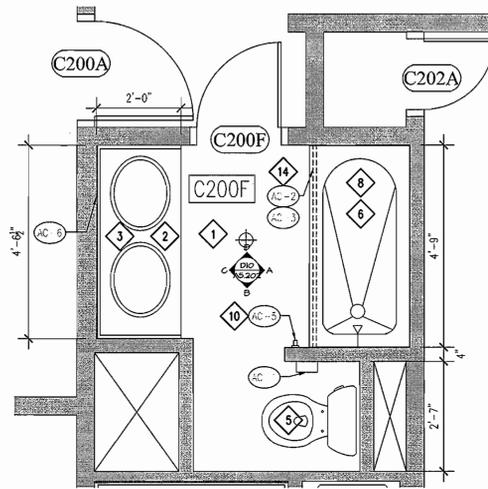

**D1C** BATHROOM FLOOR PLAN  
SCALE: 1/2" = 1'-0"

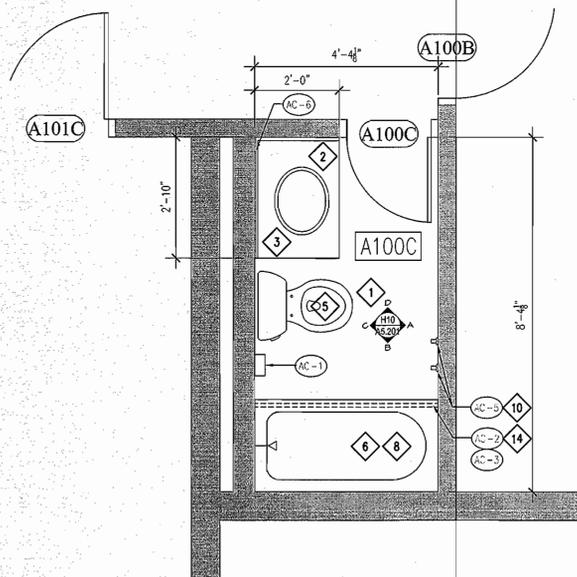

**D7** BATHROOM FLOOR PLAN (TYPICAL @ 2ND, 3RD & 4TH FLOOR)  
SCALE: 1/2" = 1'-0"

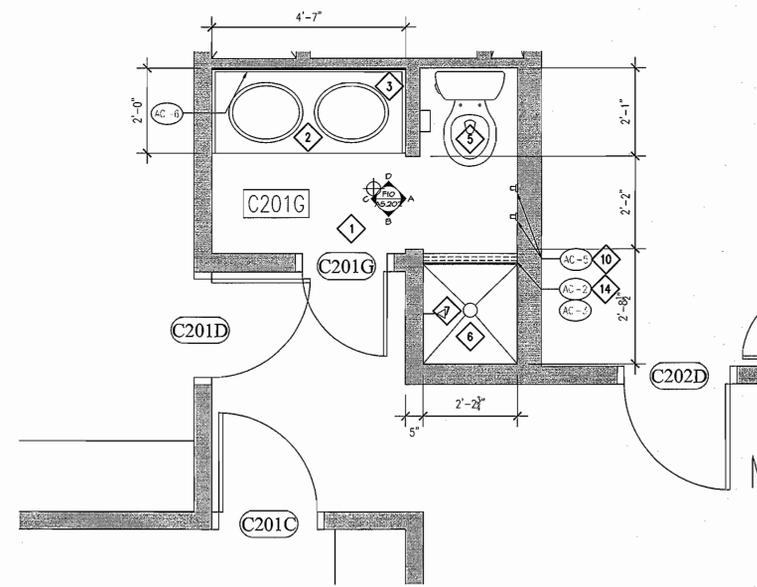

**D3** BATHROOM FLOOR PLAN (TYPICAL @ 2ND, 3RD & 4TH FLOOR)  
SCALE: 1/2" = 1'-0"

**CONSTRUCTION NOTES**

1. PREPARE SUBFLOOR AND INSTALL NEW 2X2 CERAMIC TILE FLOORING & COVE.
2. INSTALL NEW SOLID SURFACE COUNTER, BACK SPLASH, SIDE SPLASH AND INTEGRAL SINKS. CONNECT TO EXISTING SUPPLY AND DRAIN.
- 2A. INSTALL NEW WALL MOUNTED SINK CONNECT TO EXISTING SUPPLY AND DRAIN.
3. INSTALL NEW FAUCETS AND VALVES.
4. INSTALL FIBER REINFORCED PANELS FLOOR TO UNDERSIDE OF DECK ON ALL BATHROOM WALLS (EXCEPT @ SHOWER & BATHTUB STALLS - SEE ALSO DETAIL B10/A2.201).
5. INSTALL NEW TOILET AND RECONNECT TO SUPPLY AND DRAIN.
6. INSTALL NEW BATHTUB DRAIN, VALVE AND SHOWERHEAD. (WORK TO BE PERFORMED BY BATHTUBTERS).
7. INSTALL NEW BATHTUBTERS SHOWER ENCLOSURES INCLUDING SHOWER PAN, WALL INSERTS & CEILING. (WORK TO BE PERFORMED BY BATHTUBTERS).
8. INSTALL NEW BATHTUBTERS BATHTUB LINER & WALL INSERTS. (WORK TO BE PERFORMED BY BATHTUBTERS).
9. INSTALL NEW DRAIN. (WORK TO BE PERFORMED BY BATHTUBTERS).
10. INSTALL NEW STAINLESS STEEL ROBE HOOKS @ 6'-0" A.F.F. REFER TO INTERIOR ELEVATIONS - AS.201/AS.202 FOR LOCATIONS.
11. PROVIDE AND INSTALL ONE WALL MOUNTED UP/DOWN FLUORESCENT LIGHT FIXTURE ABOVE SINK AND ONE CEILING MOUNTED LIGHT FIXTURE IN FRONT OF SHOWER (SEE REFLECTED CEILING PLAN). INSTALLATION INCLUDES WIREMOLD, WIRE AND SWITCH.
12. FURNISH AND INSTALL ONE 16" DEEP HEAVY DUTY, PLASTIC COATED METAL WIRE SHELF SET 8" A.F.F.
13. REINSTALL EXHAUST GRILLE IN CEILING.
14. INSTALL NEW SHOWER ROD AND CURTAIN AT EXISTING HEIGHT.
15. INSTALL ACCESS PANELS. REPLACE DAMAGED UNITS. (CONTINGENCY ALLOWANCE)
16. INSTALL NEW DOOR AND TRANSOM AS PER SCHEDULE. PATCH AND REPAIR EXISTING DOOR FRAME AND PAINT.

**TOILET ACCESSORIES**

- AC-1 TOILET PAPER HOLDER TO BE PROVIDED BY OWNER AND INSTALLED BY CONTRACTOR.
- AC-2 STAINLESS STEEL, SATIN FINISH SHOWER ROD & MOUNTING BRACKETS.
- AC-3 SHOWER CURTAIN AND SHOWER CURTAIN RINGS
- AC-4 NEW HEAVY DUTY METAL WIRE SHELF - MOUNTED 8" A.F.F.
- AC-5 NEW STAINLESS STEEL ROBE HOOKS MTD. 6'-0" A.F.F.
- AC-6 NEW FRAMELESS MIRROR - REFER TO INTERIOR ELEVATIONS - AS.201/AS.202 FOR SIZES.
- AC-7 8" DEEP SOLID SURFACE PLASTIC SHELF.

**NOTE:**

1. BATHTUBTERS INSTALLATION TO BE DONE LAST.



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Consultant:



Owner:

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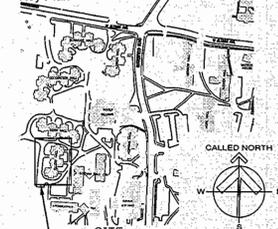
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Project:

University of Rhode Island  
ELLERY HALL BATHROOM  
RENOVATION & DOOR &  
SIGNAGE REPLACEMENT  
KINGSTON, RI

Key Plan:



Seals:



ISSUES

Date	Description
12/20/2012	FOR CONSTRUCTION

Revisions

No.	Date	Description
1	12/05/2012	REVIEW

Drawing Title

**BATHROOM CONSTRUCTION FLOOR PLANS**

Issue Date: 12/20/2012

Project No: KC.F.R.O.G.W. 2010.001 Scale: AS NOTED


Project Manager: MT Production Leader: MS

Project Architect: MT Peer Reviewer: JM


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**A2.202**


**H10** BATHROOM REFLECTED CEILING PLAN  
SCALE: 1/2" = 1'-0"

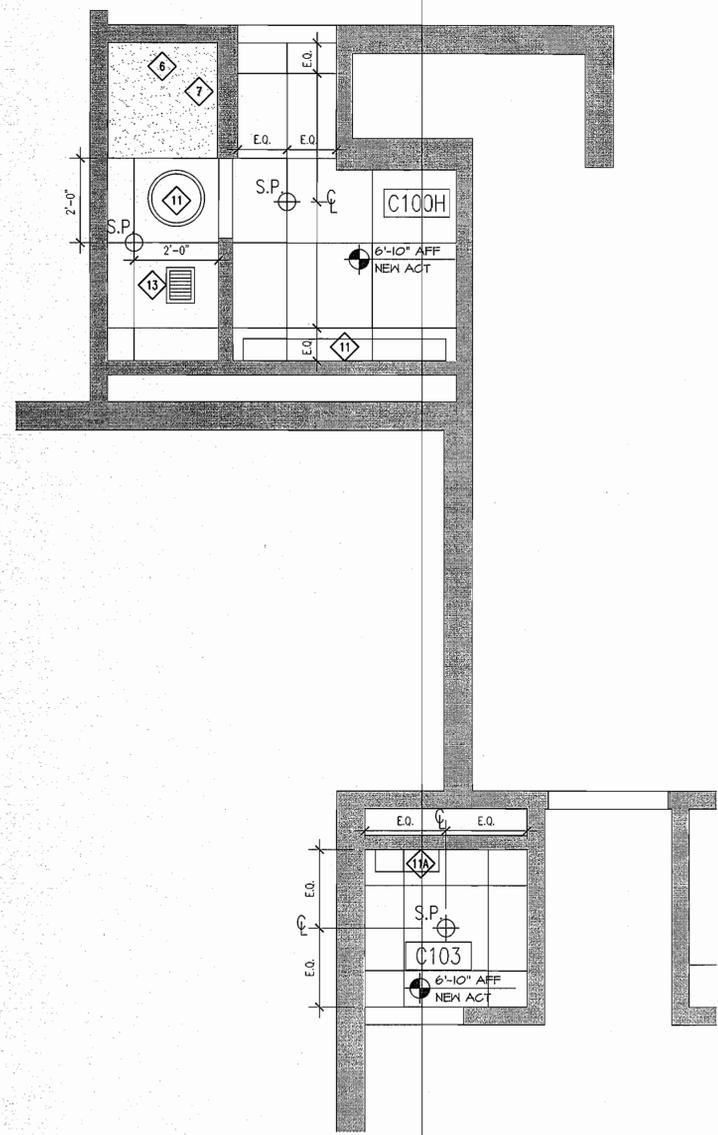

**H6** BATHROOM REFLECTED CEILING PLAN  
SCALE: 1/2" = 1'-0"

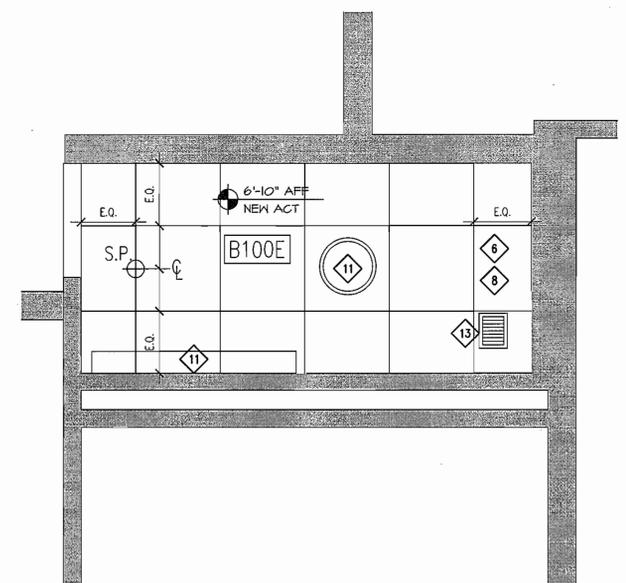

**E6** BATHROOM REFLECTED CEILING PLAN  
SCALE: 1/2" = 1'-0"

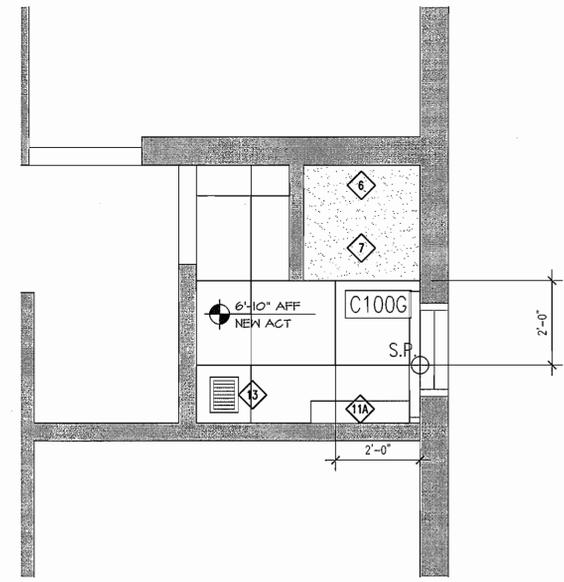


**CONSTRUCTION NOTES**

- 1 PREPARE SUBFLOOR AND INSTALL NEW 2X2 CERAMIC TILE FLOORING & COVE.
- 2 INSTALL NEW SOLID SURFACE COUNTER, BACK SPLASH, SIDE SPLASH AND INTEGRAL SINKS. CONNECT TO EXISTING SUPPLY AND DRAIN.
- 2A INSTALL NEW WALL MOUNTED SINK CONNECT TO EXISTING SUPPLY AND DRAIN.
- 3 INSTALL NEW FAUCETS AND VALVES.
- 4 INSTALL FIBER REINFORCED PANELS FLOOR TO UNDERSIDE OF DECK ON ALL BATHROOM WALLS (EXCEPT @ SHOWER & BATHUB STALLS - SEE ALSO DETAIL B10/A2.201).
- 5 INSTALL NEW TOILET AND RECONNECT TO SUPPLY AND DRAIN.
- 6 INSTALL NEW BATHFITTERS DRAIN, VALVE AND SHOWERHEAD. (WORK TO BE PERFORMED BY BATHFITTERS).
- 7 INSTALL NEW BATHFITTERS SHOWER ENCLOSURES INCLUDING SHOWER PAN, WALL INSERTS & CEILING. (WORK TO BE PERFORMED BY BATHFITTERS).
- 8 INSTALL NEW BATHFITTERS BATHUB LINER & WALL INSERTS. (WORK TO BE PERFORMED BY BATHFITTERS).
- 9 INSTALL NEW DRAIN. (WORK TO BE PERFORMED BY BATHFITTERS).
- 10 INSTALL NEW STAINLESS STEEL ROBE HOOKS @ 6'-0" AFF. REFER TO INTERIOR ELEVATIONS - AS.201/AS.202 FOR LOCATIONS.
- 11 PROVIDE AND INSTALL ONE WALL MOUNTED UP/DOWN FLUORESCENT LIGHT FIXTURE ABOVE SINK AND ONE CEILING MOUNTED LIGHT FIXTURE IN FRONT OF SHOWER (SEE REFLECTED CEILING PLAN). INSTALLATION INCLUDES WIREMOLD, WIRE AND SWITCH.
- 11A PROVIDE AND INSTALL ONE WALL MOUNTED UP/DOWN LIGHT FIXTURE ABOVE SINK. (SEE REFLECTED CEILING PLAN). INSTALLATION INCLUDES WIREMOLD, WIRE AND SWITCH.
- 12 FURNISH AND INSTALL ONE 16" DEEP HEAVY DUTY, PLASTIC COATED METAL WIRE SHELF SET 8" A.F.F.
- 13 REINSTALL EXHAUST GRILLE IN CEILING.
- 14 INSTALL NEW SHOWER ROD AND CURTAIN AT EXISTING HEIGHT.
- 15 INSTALL ACCESS PANELS. REPLACE DAMAGED UNITS. (CONTINGENCY ALLOWANCE)
- 16 INSTALL NEW DOOR AND TRANSOM AS PER SCHEDULE. PATCH AND REPAIR EXISTING DOOR FRAME AND PAINT.

**TOILET ACCESSORIES**

- AC-1 TOILET PAPER HOLDER. TO BE PROVIDED BY OWNER AND INSTALLED BY CONTRACTOR.
- AC-2 STAINLESS STEEL, SATIN FINISH SHOWER ROD & MOUNTING BRACKETS.
- AC-3 SHOWER CURTAIN AND SHOWER CURTAIN RINGS
- AC-4 NEW HEAVY DUTY METAL WIRE SHELF - MOUNTED 8" A.F.F.
- AC-5 NEW STAINLESS STEEL ROBE HOOKS WTD. 6'-0" A.F.F.
- AC-6 NEW FRAMELESS MIRROR - REFER TO INTERIOR ELEVATIONS - AS.201/5.202 FOR SIZING.
- AC-7 8" DEEP SOLID SURFACE PLASTIC SHELF.

**REFLECTED CEILING PLAN LEGEND**

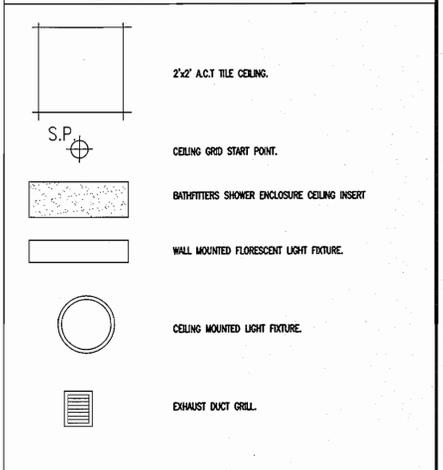

**NOTE:**  
1. BATHFITTERS INSTALLATION TO BE DONE LAST.




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KINGSTON, RI**




**ISSUES**

Date	Description
12/20/2012	FOR CONSTRUCTION


**Revisions**

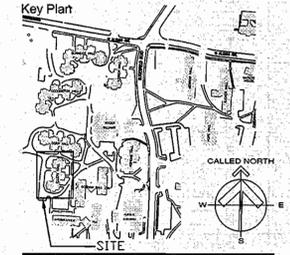No.	Date	Description
1	12/05/2012	REVIEW


Drawing Title  
**BATHROOM REFLECTED CEILING PLANS**  
Issue Date: 12/20/2012  
Project No: KC.R.ROG.W. 2010.001 Scale: AS NOTED  
Project Manager: MT Production Leader: MS  
Project Architect: MT Peer Reviewer: JM  
Drawing Number  
**A2.301**

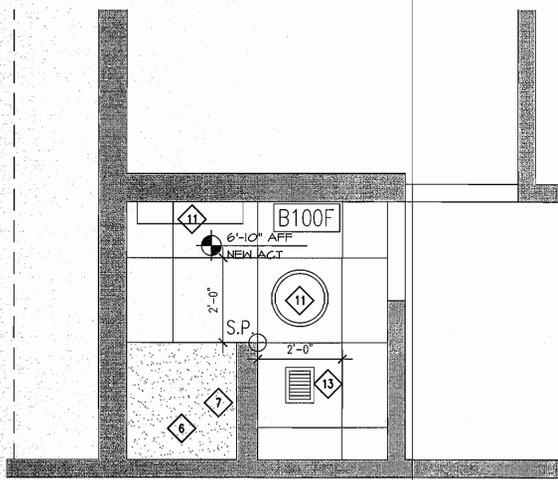


**D10** BATHROOM REFLECTED CEILING PLAN  
SCALE: 1/2" = 1'-0"

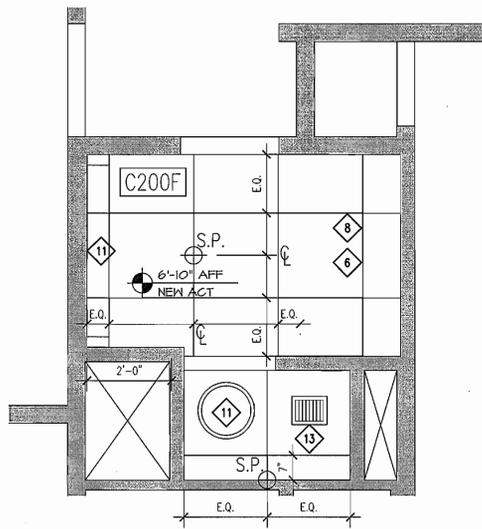


**D7** BATHROOM REFLECTED CEILING PLAN (TYPICAL @ 2ND, 3RD & 4TH FLOOR)  
SCALE: 1/2" = 1'-0"

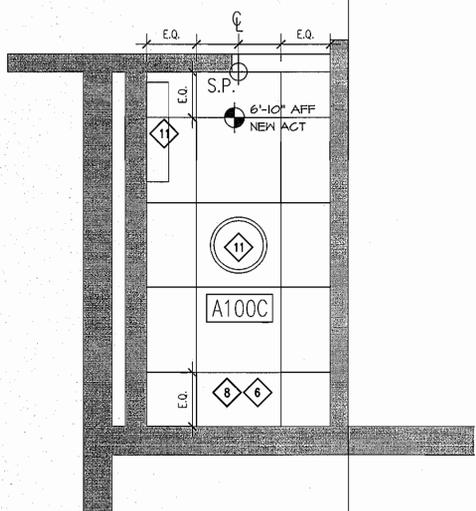

**H10** BATHROOM REFLECTED CEILING PLAN  
SCALE: 1/2" = 1'-0"

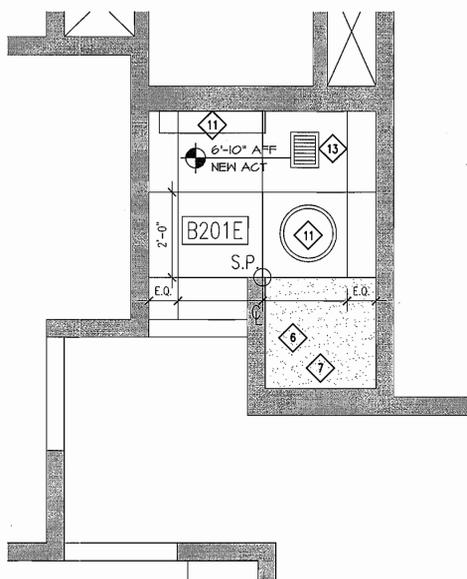

**H7** BATHROOM REFLECTED CEILING PLAN (TYPICAL @ 2ND, 3RD & 4TH FLOOR)  
SCALE: 1/2" = 1'-0"

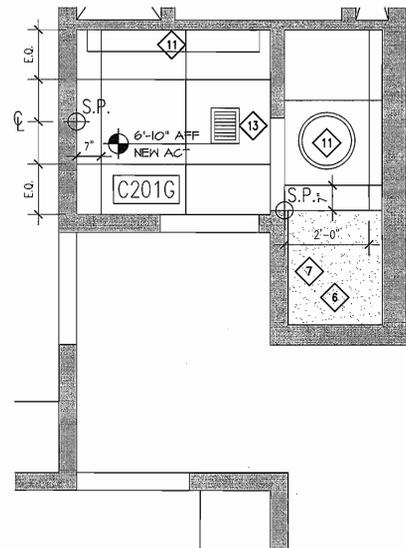

**H4** BATHROOM REFLECTED CEILING PLAN (TYPICAL @ 2ND, 3RD & 4TH FLOOR)  
SCALE: 1/2" = 1'-0"


**CONSTRUCTION NOTES**

- 1 PREPARE SUBFLOOR AND INSTALL NEW 2X2 CERAMIC TILE FLOORING & COVE.
- 2 INSTALL NEW SOLID SURFACE COUNTER, BACK SPLASH, SIDE SPLASH AND INTEGRAL SINKS. CONNECT TO EXISTING SUPPLY AND DRAIN.
- 2A INSTALL NEW WALL MOUNTED SINK CONNECT TO EXISTING SUPPLY AND DRAIN.
- 3 INSTALL NEW FAUCETS AND VALVES.
- 4 INSTALL FIBER REINFORCED PANELS FLOOR TO UNDERSIDE OF DECK ON ALL BATHROOM WALLS (EXCEPT @ SHOWER & BATHUB STALLS - SEE ALSO DETAIL B10/A2.201).
- 5 INSTALL NEW TOILET AND RECONNECT TO SUPPLY AND DRAIN.
- 6 INSTALL NEW BATHFITTERS DRAIN, VALVE AND SHOWERHEAD. (WORK TO BE PERFORMED BY BATHFITTERS).
- 7 INSTALL NEW BATHFITTERS SHOWER ENCLOSURES INCLUDING SHOWER PAN, WALL INSERTS & CEILING. (WORK TO BE PERFORMED BY BATHFITTERS).
- 8 INSTALL NEW BATHFITTERS BATHUB LINER & WALL INSERTS. (WORK TO BE PERFORMED BY BATHFITTERS).
- 9 INSTALL NEW DRAIN. (WORK TO BE PERFORMED BY BATHFITTERS).
- 10 INSTALL NEW STAINLESS STEEL ROBE HOOKS @ 6'-0" AFF. REFER TO INTERIOR ELEVATIONS - A5.201/A5.202 FOR LOCATIONS.
- 11 PROVIDE AND INSTALL ONE WALL MOUNTED UP/DOWN FLUORESCENT LIGHT FIXTURE ABOVE SINK AND ONE CEILING MOUNTED LIGHT FIXTURE IN FRONT OF SHOWER (SEE REFLECTED CEILING PLAN). INSTALLATION INCLUDES WIREMOLD, WIRE AND SWITCH.
- 11A PROVIDE AND INSTALL ONE WALL MOUNTED UP/DOWN LIGHT FIXTURE ABOVE SINK. (SEE REFLECTED CEILING PLAN). INSTALLATION INCLUDES WIREMOLD, WIRE AND SWITCH.
- 12 FURNISH AND INSTALL ONE 16" DEEP HEAVY DUTY, PLASTIC COATED METAL WIRE SHELF SET 8" A.F.F.
- 13 REINSTALL EXHAUST GRILLE IN CEILING.
- 14 INSTALL NEW SHOWER ROD AND CURTAIN AT EXISTING HEIGHT.
- 15 INSTALL ACCESS PANELS. REPLACE DAMAGED UNITS. (CONTINGENCY ALLOWANCE)
- 16 INSTALL NEW DOOR AND TRANSOM AS PER SCHEDULE. PATCH AND REPAIR EXISTING DOOR FRAME AND PAINT.

**TOILET ACCESSORIES**

- AC-1 TOILET PAPER HOLDER. TO BE PROVIDED BY OWNER AND INSTALLED BY CONTRACTOR.
- AC-2 STAINLESS STEEL, SATIN FINISH SHOWER ROD & MOUNTING BRACKETS.
- AC-3 SHOWER CURTAIN AND SHOWER CURTAIN RINGS
- AC-4 NEW HEAVY DUTY METAL WIRE SHELF - MOUNTED 8" A.F.F.
- AC-5 NEW STAINLESS STEEL ROBE HOOKS MTD. 6'-0" A.F.F.
- AC-6 NEW FRAMELESS MIRROR - REFER TO INTERIOR ELEVATIONS - A5.201/5.202 FOR SIZING.
- AC-7 8" DEEP SOLID SURFACE PLASTIC SHELF.

**REFLECTED CEILING PLAN LEGEND**

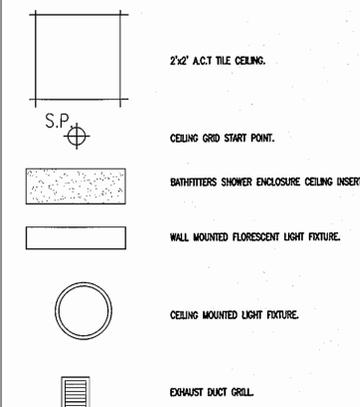

**NOTE:**

1. BATHFITTERS INSTALLATION TO BE DONE LAST.



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Consultant



Owner

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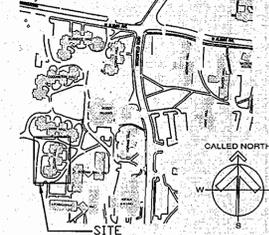
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Project

**University of Rhode Island  
ELLERY HALL BATHROOM  
RENOVATION & DOOR &  
SIGNAGE REPLACEMENT  
KINGSTON, RI**

Key Plan



Seals



ISSUES

Date	Description
12/20/2012	FOR CONSTRUCTION

Revisions

No.	Date	Description
1	12/05/2012	REVIEW

Drawing Title

**BATHROOM REFLECTED CEILING PLANS**

Issue Date: 12/20/2012


Project No: KC\_R.ROGW.2010.001 Scale: AS NOTED

Project Manager: MT Production Leader: MS

Project Architect: MT Peer Reviewer: JM

Drawing Number

**A2.302**

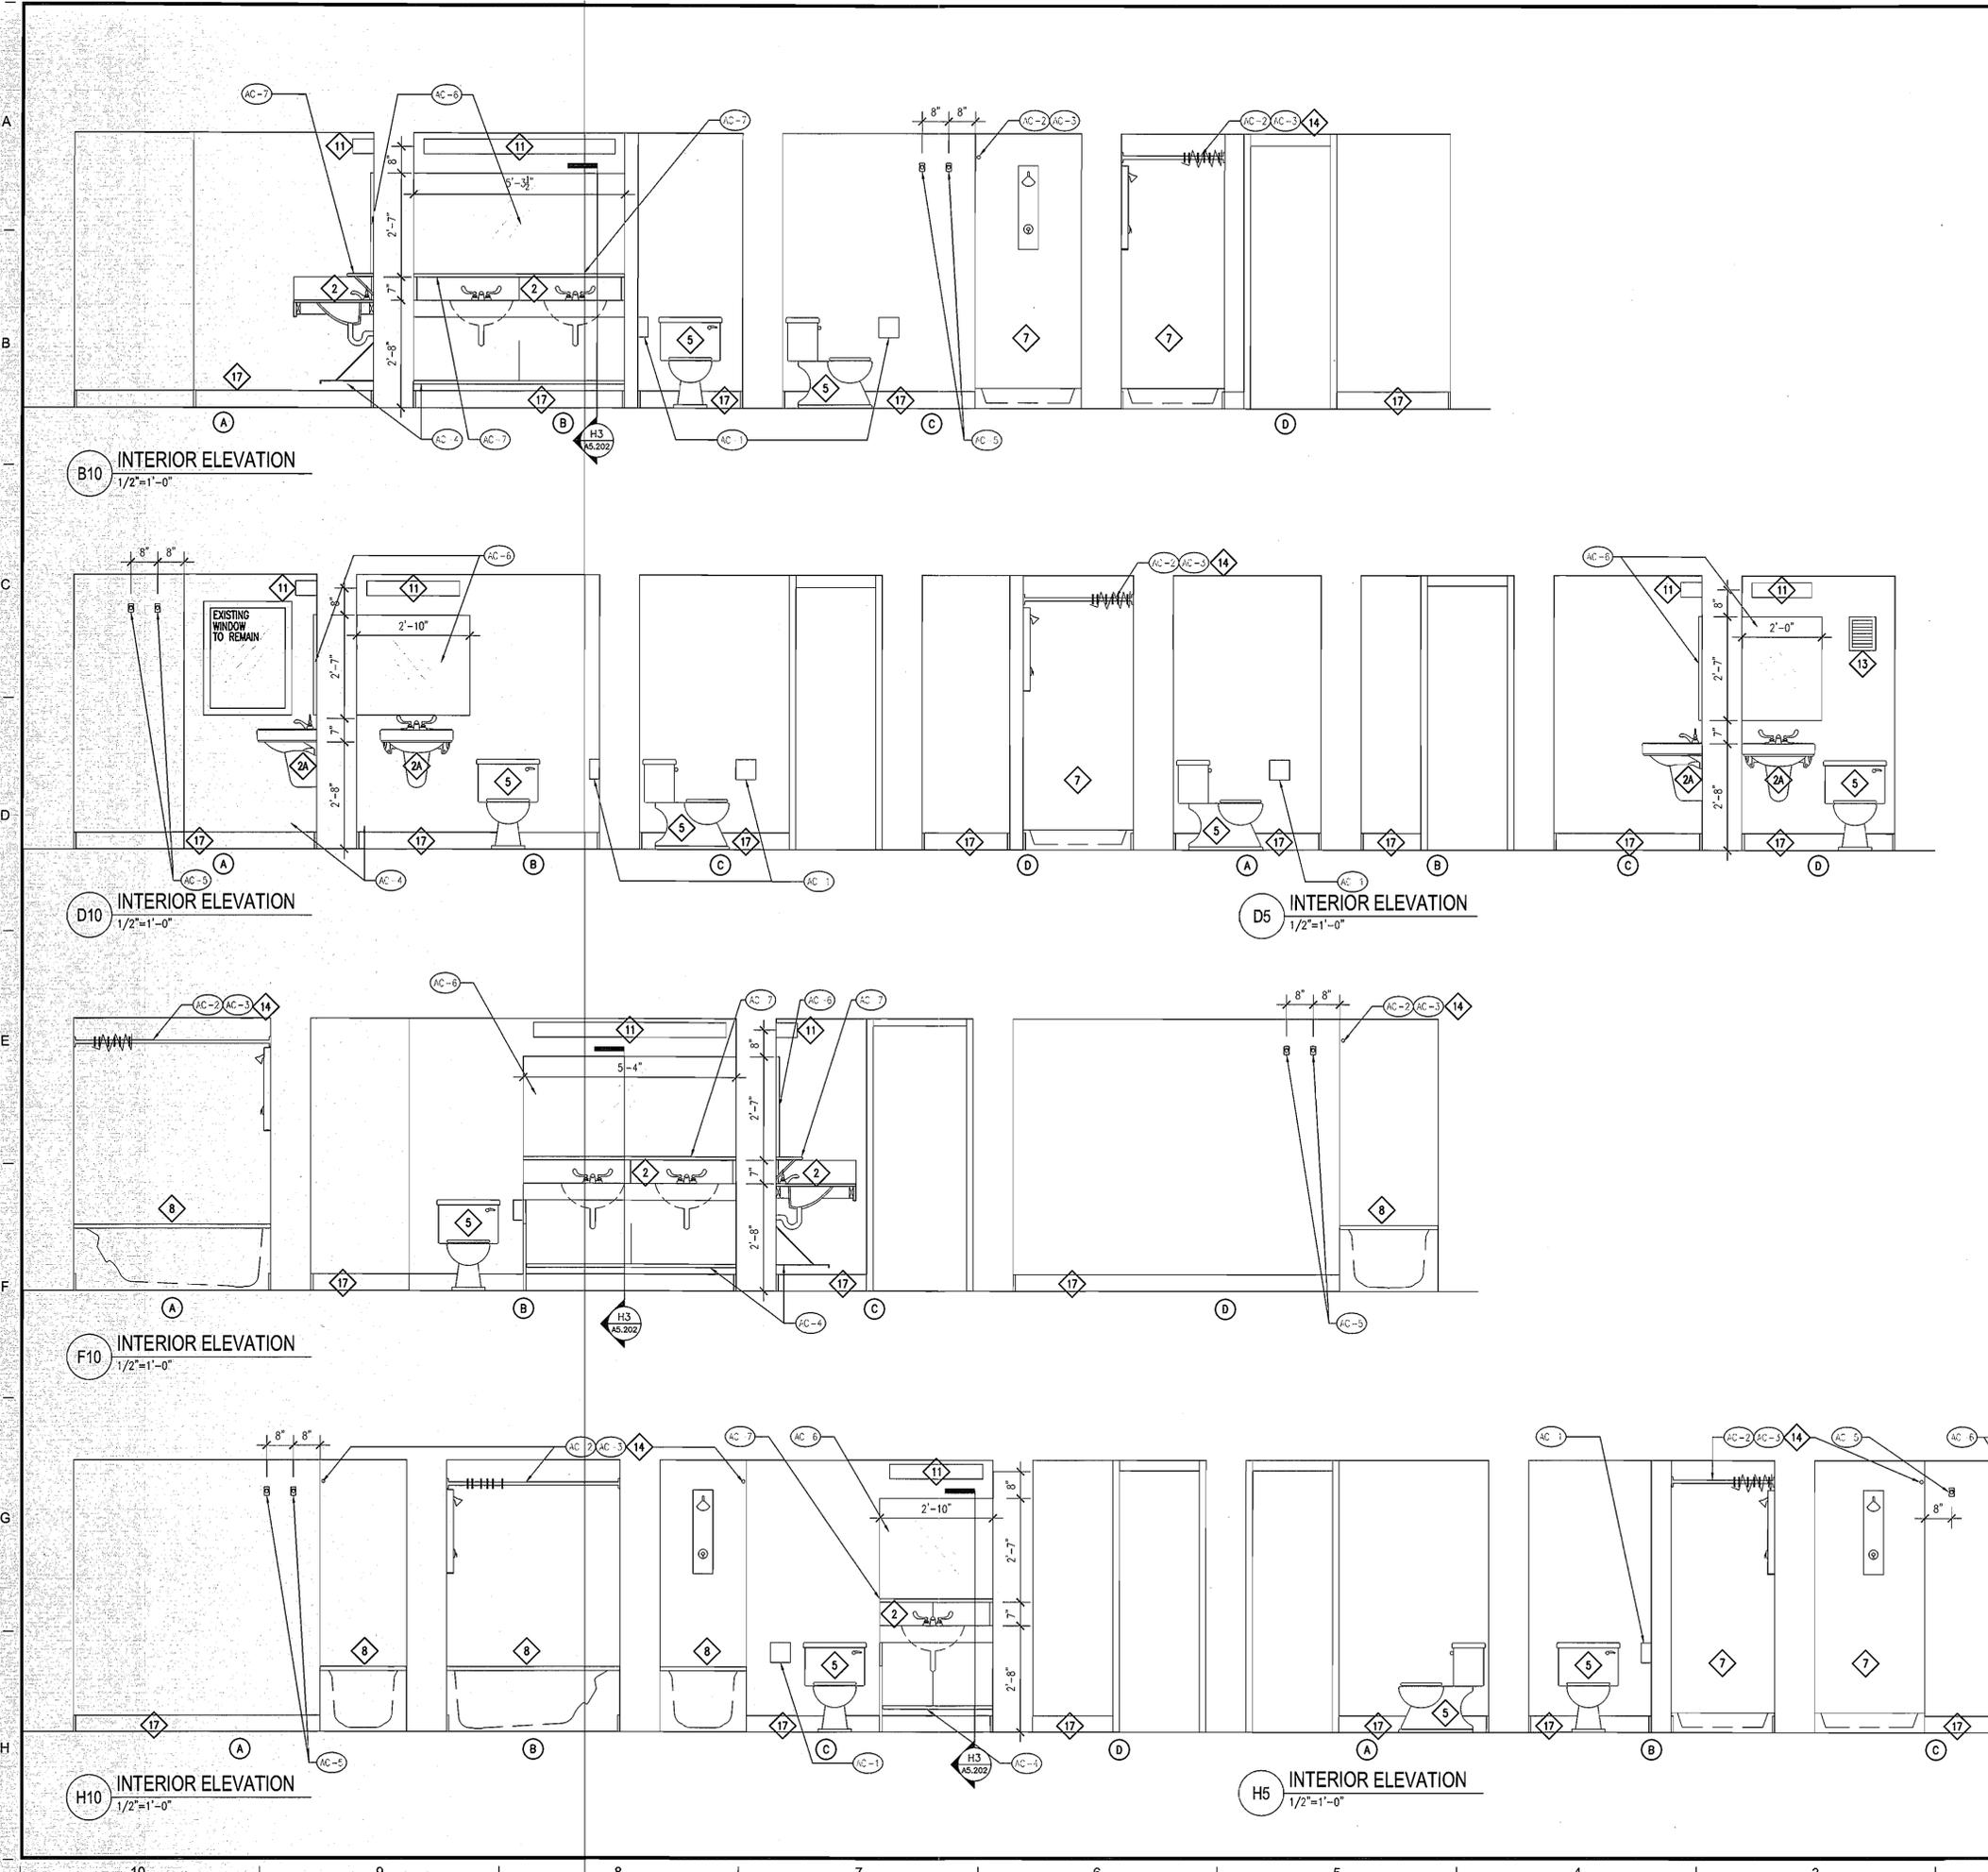

- CONSTRUCTION NOTES**
- 1 PREPARE SUBFLOOR AND INSTALL NEW 2X2 CERAMIC TILE FLOORING & COVE.
  - 2 INSTALL NEW SOLID SURFACE COUNTER, BACK SPLASH, SIDE SPLASH AND INTEGRAL SINKS. CONNECT TO EXISTING SUPPLY AND DRAIN.
  - 2A INSTALL NEW WALL MOUNTED SINK CONNECT TO EXISTING SUPPLY AND DRAIN.
  - 3 INSTALL NEW FAUCETS AND VALVES.
  - 4 INSTALL FIBER REINFORCED PANELS FLOOR TO CEILING ON ALL BATHROOM WALLS (EXCEPT @ SHOWER & BATHTUB STALLS - REFER TO DETAIL B10/A2.201).
  - 5 INSTALL NEW TOILET AND RECONNECT TO SUPPLY AND DRAIN.
  - 6 INSTALL NEW BATHTUBS DRAIN, VALVE AND SHOWERHEAD. (WORK TO BE PERFORMED BY BATHTUBBERS).
  - 7 INSTALL NEW BATHTUBS SHOWER ENCLOSURES INCLUDING SHOWER PAN, WALL INSERTS & CEILING. (WORK TO BE PERFORMED BY BATHTUBBERS).
  - 8 INSTALL NEW BATHTUBS BATHTUB LINER & WALL INSERTS. (WORK TO BE PERFORMED BY BATHTUBBERS).
  - 9 INSTALL NEW DRAIN. (WORK TO BE PERFORMED BY BATHTUBBERS).
  - 10 INSTALL NEW STAINLESS STEEL ROBE HOOKS @ 6'-0" AFF. REFER TO INTERIOR ELEVATIONS - AS.201/AS.202 FOR LOCATIONS.
  - 11 PROVIDE AND INSTALL ONE WALL MOUNTED UP/DOWN FLUORESCENT LIGHT FIXTURE ABOVE SINK AND ONE CEILING MOUNTED LIGHT FIXTURE IN FRONT OF SHOWER (SEE REFLECTED CEILING PLAN). INSTALLATION INCLUDES WIREMOLD, WIRE AND SWITCH.
  - 11A PROVIDE AND INSTALL ONE WALL MOUNTED UP/DOWN FLUORESCENT LIGHT FIXTURE ABOVE SINK (SEE REFLECTED CEILING PLAN). INSTALLATION INCLUDES WIREMOLD, WIRE AND SWITCH.
  - 12 FURNISH AND INSTALL ONE 16" DEEP HEAVY DUTY, PLASTIC COATED METAL WIRE SHELF SET 8" A.F.F.
  - 13 REINSTALL EXHAUST GRILLE IN CEILING.
  - 14 INSTALL NEW SHOWER ROD AND CURTAIN AT EXISTING HEIGHT.
  - 15 INSTALL ACCESS PANELS. REPLACE DAMAGED UNITS. (CONTINGENCY ALLOWANCE)
  - 16 INSTALL NEW DOOR AND TRANSOM AS PER SCHEDULE. PATCH AND REPAIR EXISTING DOOR FRAME AND PAINT.
  - 17 5" TILE COVE BASE ON ALL WALLS.
- TOILET ACCESSORIES**
- AC-1 TOILET PAPER HOLDER. TO BE PROVIDED BY OWNER AND INSTALLED BY CONTRACTOR.
  - AC-2 STAINLESS STEEL, SATIN FINISH SHOWER ROD & MOUNTING BRACKETS.
  - AC-3 SHOWER CURTAIN AND SHOWER CURTAIN RINGS
  - AC-4 NEW HEAVY DUTY METAL WIRE SHELF - MOUNTED 8" A.F.F.
  - AC-5 NEW STAINLESS STEEL ROBE HOOKS MTD. 6'-0" A.F.F.
  - AC-6 NEW FRAMELESS MIRROR - REFER TO INTERIOR ELEVATIONS - AS.201/AS.202 FOR SIZING.
  - AC-7 8" DEEP SOLID SURFACE PLASTIC SHELF.
- NOTE:**
1. BATHTUBS INSTALLATION TO BE DONE LAST.

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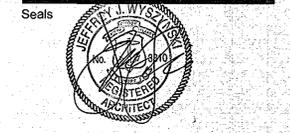
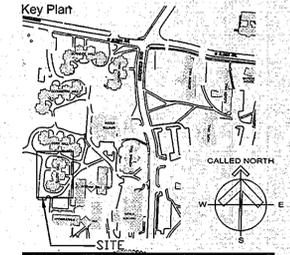
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Owner  
**THE UNIVERSITY OF RHODE ISLAND**

THINK BIG WE DO

Project  
**University of Rhode Island  
 ELLERY HALL BATHROOM  
 RENOVATION & DOOR &  
 SIGNAGE REPLACEMENT  
 KINGSTON, RI**



ISSUES

Date	Description
12/20/2012	FOR CONSTRUCTION

Revisions

No.	Date	Description
1	12/05/2012	REVIEW

Drawing Title  
**FIRST FLOOR  
 BATHROOM  
 INTERIOR  
 ELEVATIONS**

Issue Date: 12/20/2012


Project No: KC.R.ROGW.2010.001 Scale: AS NOTED

Project Manager: MT Production Leader: MS

Project Architect: MT Peer Reviewer: JM


Drawing Number

**A5.201**

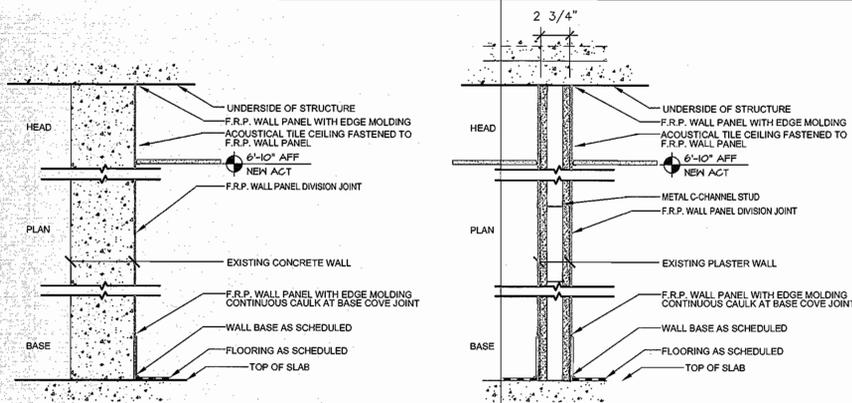


1 EXISTING 6" CONCRETE PARTITION  
2 EXISTING PLASTER ON METAL LATH


C10 WALL TYPES  
1-1/2"=1'-0"

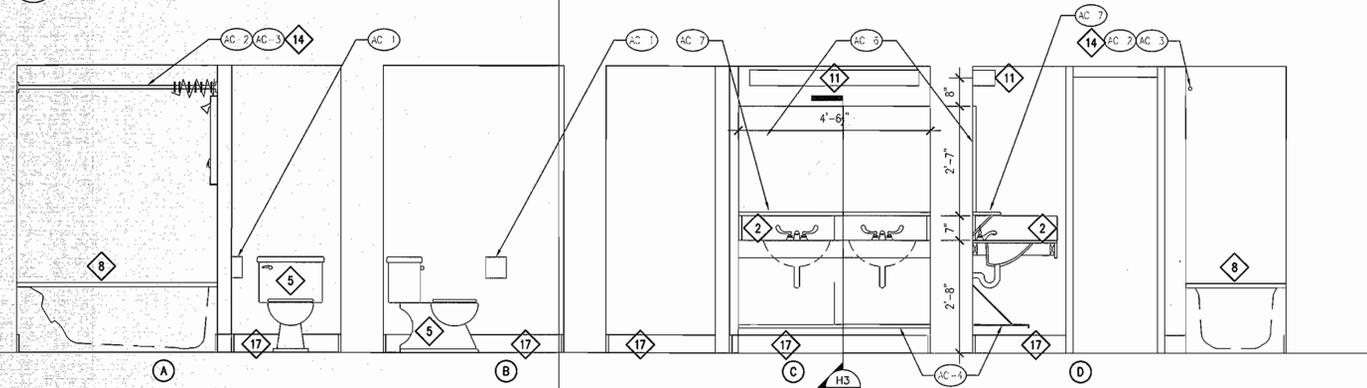

D10 INTERIOR ELEVATION - SECOND THIRD & FOURTH FLOORS  
1/2"=1'-0"

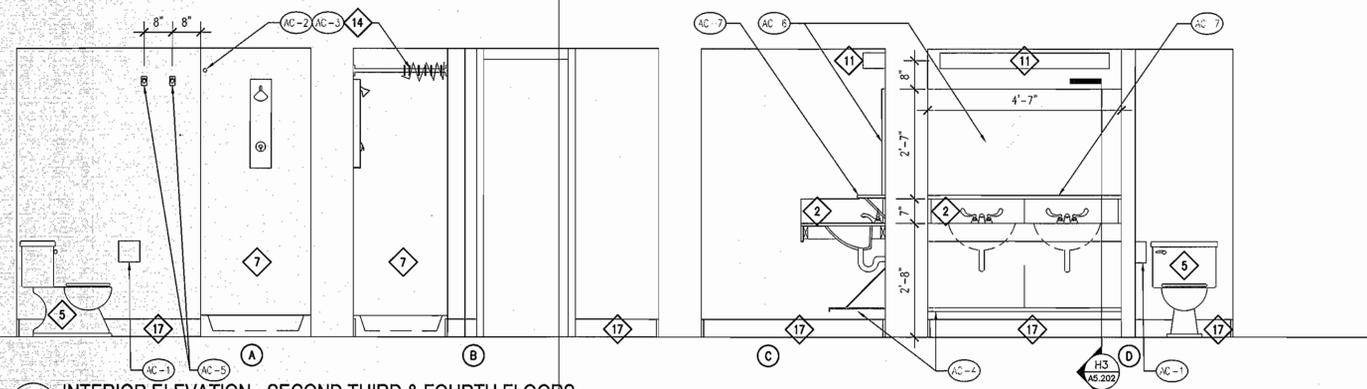

F10 INTERIOR ELEVATION - SECOND THIRD & FOURTH FLOORS  
1/2"=1'-0"

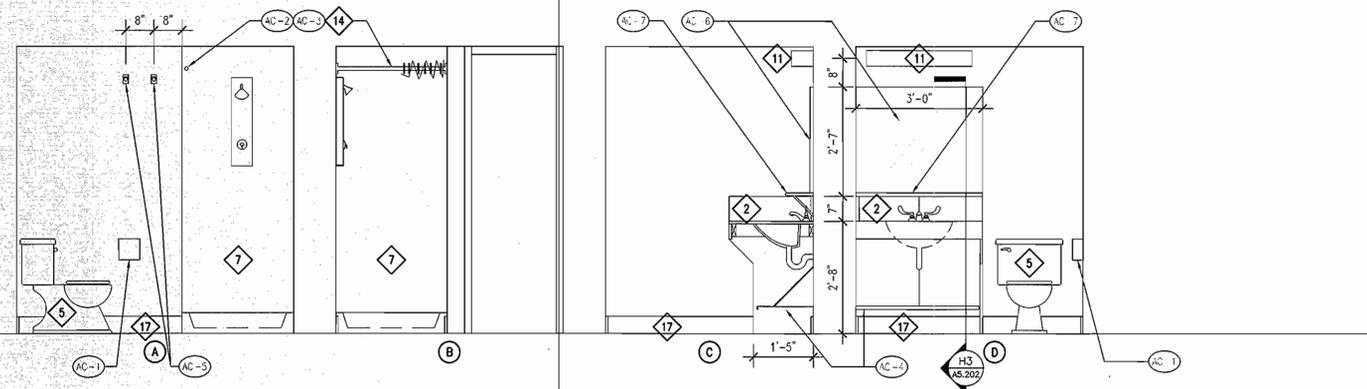

H10 INTERIOR ELEVATION - SECOND THIRD & FOURTH FLOORS  
1/2"=1'-0"

**FINISH LEGEND**

- 2x2 MOSAIC FLOOR TILE - REFER TO SPECIFICATION
- CT-1 5" CERAMIC WALL TILE COVE BASE - REFER TO SPECIFICATION
- F.R.P. WALL COVERING - F.R.P. WALL PANEL ADHERED TO EXISTING WALL SURFACE TO BE INSTALLED ON ALL WALL SURFACE EXCEPT FOR WHERE BATHTIFTERS TUB AND SHOWER ENCLOSURES ARE TO BE INSTALLED. - REFER TO SPECIFICATION & SEE ALSO DETAIL B10 /A2.201.
- ACT FIBERGLASS ACOUSTICAL TILE CEILING - REFER TO SPECIFICATION.
- SS-1 COUNTER TOP MATERIAL TO BE SOLID SURFACE - REFER TO SPECIFICATION.
- PT-1 BONDO PATCH ANY DAMAGE TO EXISTING BATHROOM DOOR FRAMES, SAND SMOOTH AND PAINT - REFER TO SPECIFICATION.
- FLOOR DRAIN. SEE "P" DRAWINGS.

**GENERAL FINISH NOTES**

1. FINISH PLAN IS FOR REFERENCE & TO BE APPLICABLE AT ALL BATHROOMS.
2. COORDINATE ALL FINISHES WITH SPECIFICATIONS.


- CONSTRUCTION NOTES**
1. PREPARE SUBFLOOR AND INSTALL NEW 2X2 CERAMIC TILE FLOORING & COVE.
  2. INSTALL NEW SOLID SURFACE COUNTER, BACK SPLASH, SIDE SPLASH AND INTEGRAL SINKS. CONNECT TO EXISTING SUPPLY AND DRAIN.
  - 2A. INSTALL NEW WALL MOUNTED SINK CONNECT TO EXISTING SUPPLY AND DRAIN.
  3. INSTALL NEW FAUCETS AND VALVES.
  4. INSTALL FIBER REINFORCED PANELS FLOOR TO CEILING ON ALL BATHROOM WALLS (EXCEPT @ SHOWER & BATHTUB STALLS - REFER TO DETAIL B10/A2.201).
  5. INSTALL NEW TOILET AND RECONNECT TO SUPPLY AND DRAIN.
  6. INSTALL NEW BATHTIFTERS DRAIN, VALVE AND SHOWERHEAD. (WORK TO BE PERFORMED BY BATHTIFTERS).
  7. INSTALL NEW BATHTIFTERS SHOWER ENCLOSURES INCLUDING SHOWER PAN, WALL INSERTS & CEILING. (WORK TO BE PERFORMED BY BATHTIFTERS).
  8. INSTALL NEW BATHTIFTERS BATHTUB LINER & WALL INSERTS. (WORK TO BE PERFORMED BY BATHTIFTERS).
  9. INSTALL NEW DRAIN. (WORK TO BE PERFORMED BY BATHTIFTERS).
  10. INSTALL NEW STAINLESS STEEL ROBE HOOKS @ 6'-0" AFF. REFER TO INTERIOR ELEVATIONS - AS.201/AS.202 FOR LOCATIONS.
  11. PROVIDE AND INSTALL ONE WALL MOUNTED UP/DOWN FLUORESCENT LIGHT FIXTURE ABOVE SINK AND ONE CEILING MOUNTED LIGHT FIXTURE IN FRONT OF SHOWER (SEE REFLECTED CEILING PLAN). INSTALLATION INCLUDES WIREMOLD, WIRE AND SWITCH.
  - 11A. PROVIDE AND INSTALL ONE WALL MOUNTED UP/DOWN FLUORESCENT LIGHT FIXTURE ABOVE SINK (SEE REFLECTED CEILING PLAN). INSTALLATION INCLUDES WIREMOLD, WIRE AND SWITCH.
  12. FURNISH AND INSTALL ONE 16" DEEP HEAVY DUTY, PLASTIC COATED METAL WIRE SHELF SET 8" A.F.F.
  13. REINSTALL EXHAUST GRILLE IN CEILING.
  14. INSTALL NEW SHOWER ROD AND CURTAIN AT EXISTING HEIGHT.
  15. INSTALL ACCESS PANELS. REPLACE DAMAGED UNITS. (CONTINGENCY ALLOWANCE)
  16. INSTALL NEW DOOR AND TRANSOM AS PER SCHEDULE. PATCH AND REPAIR EXISTING DOOR FRAME AND PAINT.
  17. 5" BASE TILE COVE ON ALL WALLS.

**TOILET ACCESSORIES**


- AC-1 TOILET PAPER HOLDER. TO BE PROVIDED BY OWNER AND INSTALLED BY CONTRACTOR.
- AC-2 STAINLESS STEEL, SATIN FINISH SHOWER ROD & MOUNTING BRACKETS.
- AC-3 SHOWER CURTAIN AND SHOWER CURTAIN RINGS
- AC-4 NEW HEAVY DUTY METAL WIRE SHELF - MOUNTED 8" A.F.F.
- AC-5 NEW STAINLESS STEEL ROBE HOOKS W/ID. 6'-0" A.F.F.
- AC-6 NEW FRAMELESS MIRROR - REFER TO INTERIOR ELEVATIONS - AS.201/AS.202 FOR SIZING.
- AC-7 8" DEEP SOLID SURFACE PLASTIC SHELF.

**NOTE:**

1. BATHTIFTERS INSTALLATION TO BE DONE LAST.

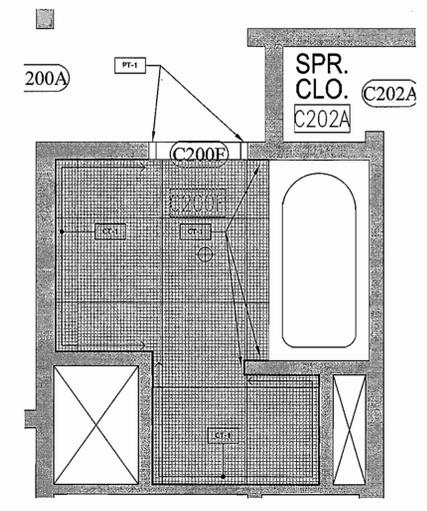

E5 TYPICAL FINISH FLOOR PLAN  
1/2"=1'-0"

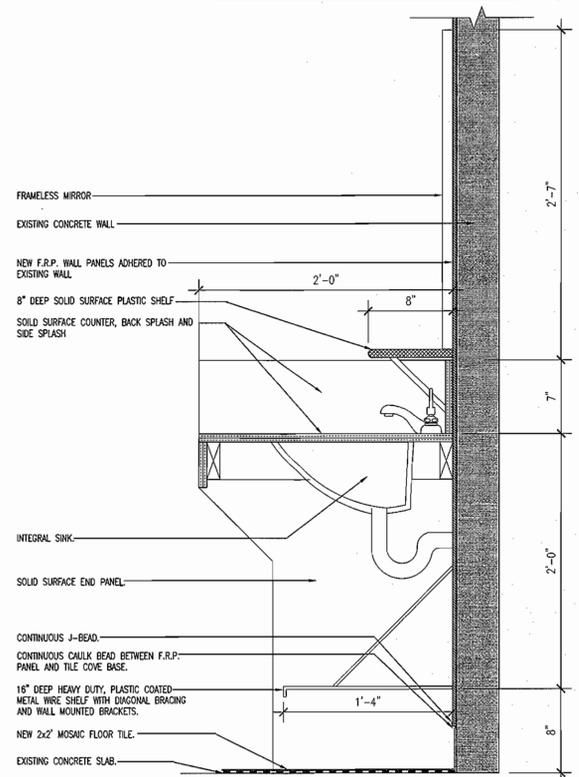

H3 SOLID SURFACE COUNTER  
1-1/2"=1'-0"

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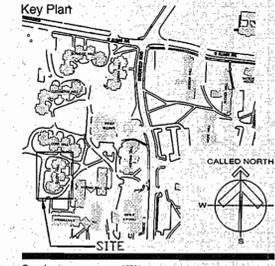
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Project  
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ELLERY HALL BATHROOM  
RENOVATION & DOOR &  
SIGNAGE REPLACEMENT  
KINGSTON, RI**



**ISSUES**

Date	Description
12/20/2012	FOR CONSTRUCTION

**Revisions**

No.	Date	Description
1	12/05/2012	REVIEW

Drawing Title  
**UPPER FLOOR  
BATHROOM INTERIOR  
ELEVATIONS & FINISH  
SCHEDULE**

Issue Date: 12/20/2012

Project No:	KG.F.ROGW.2010.001	Scale:	AS NOTED
Project Manager:	MT	Production Leader:	MS
Project Architect:	MT	Peer Reviewer:	JM

Drawing Number  
**A5.202**

**BASEMENT DOOR, FRAME & SIGNAGE SCHEDULE**

NUMBER	SIZE	DOOR				FRAME				TRANSOM	DOOR RATING	HDWR.	SIGN		TRANSOM HT. (TOP OF DOOR TO TOP OF FRAME) REMARKS
		ELEV.	MATL.	THK.	FINISH	MATL.	THK.	FINISH	ELEV.				TYPE	RM#	
A012A	EXISTING TO REMAIN	EXIST.	EXIST.	H3/F8/C9	A012B										
A012B	EXISTING TO REMAIN	EXIST.	EXIST.	H3/F8/C9	A012B										
B001	EXISTING TO REMAIN	EXIST.	EXIST.	C7	B001										
B002	EXISTING TO REMAIN	EXIST.	EXIST.	C7	B002										
B003	EXISTING TO REMAIN	EXIST.	EXIST.	C7	B003										
B004	EXISTING TO REMAIN	EXIST.	EXIST.	C7	B004										
B005	EXISTING TO REMAIN	EXIST.	EXIST.	C7	B005										
B006	EXISTING TO REMAIN	EXIST.	EXIST.	C10											
B007	EXISTING TO REMAIN	EXIST.	EXIST.	H3/F8/C9											
B009	EXISTING TO REMAIN	EXIST.	EXIST.	C7	C010										
B010	EXISTING TO REMAIN	EXIST.	EXIST.	H3/F8/C9											

**FIRST FLOOR DOOR, FRAME & SIGNAGE SCHEDULE**

NOTE: PRIOR TO ORDERING OF ANY UNITS ALL DIMENSIONS SHALL BE FIELD VERIFIED

NUMBER	SIZE	DOOR				FRAME				TRANSOM	DOOR RATING	HDWR.	SIGN		TRANSOM HT. (TOP OF DOOR TO TOP OF FRAME) REMARKS
		ELEV.	MATL.	THK.	FINISH	MATL.	THK.	FINISH	ELEV.				TYPE	RM#	
A100	2'-4" x 6'-8"	A	WD.	1-3/4"	TRANS.	EXIST.	EXIST.	EXIST.	A		20 MIN	1	C3/F8	A100	1'-3"
A100A	2'-4" x 6'-8"	A	WD.	1-3/4"	TRANS.	EXIST.	EXIST.	EXIST.	A		20 MIN	5			1'-3"
A100B	2'-4" x 6'-8"	A	WD.	1-3/4"	TRANS.	EXIST.	EXIST.	EXIST.	A		20 MIN	5			1'-3"
A100C	2'-4" x 6'-8"	B	WD.	1-3/4"	TRANS.	EXIST.	EXIST.	EXIST.	A		20 MIN	5	C10		1'-3"
A100D	2'-0" x 6'-8"	A	WD.	1-3/4"	TRANS.	EXIST.	EXIST.	EXIST.	A		20 MIN	5			1'-3"
A100E	3'-0" x 7'-0"	D	H.M.	1-3/4"	PT.	EXIST.	EXIST.	EXIST.	A		20 MIN	7			11"
A101A	2'-0" x 6'-8"	A	WD.	1-3/4"	TRANS.	EXIST.	EXIST.	EXIST.	A		20 MIN	3	C7	A101A	1'-3"
A101B	EXISTING TO REMAIN	EXIST.	EXIST.	C7	A101B										
A101C	EXISTING TO REMAIN	EXIST.	EXIST.	H3/F8/C9		DOORS TO STAIRS PREVIOUSLY REPLACED									
A101D	3'-0" x 6'-8"	B	H.M.	1-3/4"	PT.	EXIST.	EXIST.	EXIST.	A		90 MIN	6	H3/F8/C9		DOORS TO STAIRS PREVIOUSLY REPLACED
A102	3'-6" x 7'-6"	C	H.M.	1-3/4"	PT.	EXIST.	EXIST.	EXIST.	A		20 MIN	7			
A102A	3'-0" x 6'-8"	B	H.M.	1-3/4"	PT.	EXIST.	EXIST.	EXIST.	A		90 MIN	6	C5	A105	
A102B	3'-0" x 6'-8"	B	H.M.	1-3/4"	PT.	EXIST.	EXIST.	EXIST.	A		90 MIN	6	C5	A106	
A103	2'-0" x 6'-8"	B	WD.	1-3/4"	TRANS.	EXIST.	EXIST.	EXIST.	A		20 MIN	3	C7	A103	
A104	2'-0" x 6'-8"	B	WD.	1-3/4"	TRANS.	EXIST.	EXIST.	EXIST.	A		20 MIN	2	C10		
A105A	3'-0" x 8"	B	H.M.	1-3/4"	PT.	EXIST.	EXIST.	EXIST.	A		20 MIN	6	C5	A105A	
A107	2'-6" x 6'-8"	B	WD.	1-3/4"	TRANS.	EXIST.	EXIST.	EXIST.	B		20 MIN	3	C7	A107	
A108	2'-4" x 6'-8"	B	WD.	1-3/4"	TRANS.	EXIST.	EXIST.	EXIST.	A		20 MIN	4	C5	A108	
A109	3'-0" x 6'-11"	EXIST.	EXIST.	C5	A109										
A110	2'-8" x 6'-8"	B	WD.	1-3/4"	TRANS.	EXIST.	EXIST.	EXIST.	A		20 MIN	4	C5	A110	
A111	2'-8" x 6'-8"	B	WD.	1-3/4"	TRANS.	EXIST.	EXIST.	EXIST.	B		20 MIN	4	C5	A111	
B100	2'-8" x 6'-8"	B	WD.	1-3/4"	TRANS.	EXIST.	EXIST.	EXIST.	A		20 MIN	1			1'-3"
B100A	2'-4" x 7'-11"	A	WD.	1-3/4"	TRANS.	EXIST.	EXIST.	EXIST.	A		20 MIN	1	C3/F8	B100A	
B100B	2'-4" x 7'-11"	A	WD.	1-3/4"	TRANS.	EXIST.	EXIST.	EXIST.	A		20 MIN	1	C3/F8	B100B	
B100C	2'-4" x 7'-11"	A	WD.	1-3/4"	TRANS.	EXIST.	EXIST.	EXIST.	A		20 MIN	1	C3/F8	B100C	
B100D	2'-4" x 7'-11"	A	WD.	1-3/4"	TRANS.	EXIST.	EXIST.	EXIST.	A		20 MIN	1	C3/F8	B100D	
B100E	2'-4" x 6'-8"	B	WD.	1-3/4"	TRANS.	EXIST.	EXIST.	EXIST.	A		20 MIN	2	C10		1'-3"
B100F	2'-0" x 6'-8"	B	WD.	1-3/4"	TRANS.	EXIST.	EXIST.	EXIST.	A		20 MIN	2	C10		1'-3"
B101A	2'-0" x 6'-8"	B	WD.	1-3/4"	TRANS.	EXIST.	EXIST.	EXIST.	A		20 MIN	3	C7	B101A	
B101B	EXISTING TO REMAIN	EXIST.	EXIST.	C7	B101B										
B101C	EXISTING TO REMAIN	EXIST.	EXIST.	H3/F8/C9		DOORS TO STAIRS PREVIOUSLY REPLACED									
B101D	3'-0" x 6'-8"	B	H.M.	1-3/4"	PT.	EXIST.	EXIST.	EXIST.	A		90 MIN	6	H3/F8/C9		DOORS TO STAIRS PREVIOUSLY REPLACED
B102	3'-6" x 7'-6"	C	H.M.	1-3/4"	PT.	EXIST.	EXIST.	EXIST.	A		20 MIN	7			
B102A	3'-0" x 6'-8"	B	H.M.	1-3/4"	PT.	EXIST.	EXIST.	EXIST.	A		90 MIN	6	C5	A106	
B102B	3'-0" x 6'-8"	B	H.M.	1-3/4"	PT.	EXIST.	EXIST.	EXIST.	A		90 MIN	6	C5	B105	
B103	2'-0" x 6'-8"	B	WD.	1-3/4"	TRANS.	EXIST.	EXIST.	EXIST.	A		20 MIN	2	C10		
B104	2'-0" x 6'-8"	B	WD.	1-3/4"	TRANS.	EXIST.	EXIST.	EXIST.	A		20 MIN	3	C7	B104	
C100	2'-8" x 7'-11"	B	WD.	1-3/4"	TRANS.	EXIST.	EXIST.	EXIST.	A		20 MIN	1			1'-3"
C100A	2'-4" x 7'-11"	A	WD.	1-3/4"	TRANS.	EXIST.	EXIST.	EXIST.	A		20 MIN	1	C3/F8	C100A	
C100B	2'-4" x 7'-11"	A	WD.	1-3/4"	TRANS.	EXIST.	EXIST.	EXIST.	A		20 MIN	1	C3/F8	C100B	
C100C	2'-4" x 7'-11"	A	WD.	1-3/4"	TRANS.	EXIST.	EXIST.	EXIST.	A		20 MIN	1	C3/F8	C100C	
C100D	2'-4" x 7'-11"	A	WD.	1-3/4"	TRANS.	EXIST.	EXIST.	EXIST.	A		20 MIN	1	C3/F8	C100D	
C100E	2'-4" x 7'-11"	A	WD.	1-3/4"	TRANS.	EXIST.	EXIST.	EXIST.	A		20 MIN	1	C3/F8	C100E	
C100F	2'-4" x 7'-11"	A	H.M.	1-3/4"	PT.	EXIST.	EXIST.	EXIST.	A		90 MIN	6	C3/F8	C100F	
C100G	2'-0" x 6'-8"	B	WD.	1-3/4"	TRANS.	EXIST.	EXIST.	EXIST.	A		20 MIN	2	C10		1'-3"
C100H	2'-0" x 6'-8"	B	WD.	1-3/4"	TRANS.	EXIST.	EXIST.	EXIST.	A		20 MIN	2	C10		1'-3"
C101A	2'-0" x 6'-8"	B	WD.	1-3/4"	TRANS.	EXIST.	EXIST.	EXIST.	A		20 MIN	3	C7	C101A	1'-3"
C101B	EXISTING TO REMAIN	EXIST.	EXIST.	C7	C101B										
C101C	EXISTING TO REMAIN	EXIST.	EXIST.	H3/F8/C9		DOORS TO STAIRS PREVIOUSLY REPLACED									
C101D	3'-0" x 6'-8"	B	H.M.	1-3/4"	PT.	EXIST.	EXIST.	EXIST.	A		90 MIN	6	H3/F8/C9		DOORS TO STAIRS PREVIOUSLY REPLACED
C102	3'-6" x 7'-6"	C	H.M.	1-3/4"	PT.	EXIST.	EXIST.	EXIST.	A		20 MIN	7			
C102A	3'-0" x 6'-8"	B	H.M.	1-3/4"	PT.	EXIST.	EXIST.	EXIST.	A		90 MIN	6	C5	C106	
C103	2'-0" x 6'-8"	B	WD.	1-3/4"	TRANS.	EXIST.	EXIST.	EXIST.	A		20 MIN	2	C10		
C104	2'-0" x 6'-8"	B	WD.	1-3/4"	TRANS.	EXIST.	EXIST.	EXIST.	A		20 MIN	3	C7	C104	
C106A	2'-11" x 6'-8"	B	WD.	1-3/4"	TRANS.	EXIST.	EXIST.	EXIST.	A		20 MIN	8	C5	C107	
C108	2'-6" x 6'-8"	B	WD.	1-3/4"	TRANS.	EXIST.	EXIST.	EXIST.	A		20 MIN	3	C7	C108	

NOTE: ALL GREY BOXES SHALL INDICATE A DOOR THAT IS ASSOCIATED WITH ALTERNATE #2

**SECOND FLOOR DOOR, FRAME & SIGNAGE SCHEDULE**

NOTE: PRIOR TO ORDERING OF ANY UNITS ALL DIMENSIONS SHALL BE FIELD VERIFIED

ALTERNATE	NUMBER	SIZE	DOOR				FRAME				TRANSOM	DOOR RATING	HDWR.	SIGN		TRANSOM HT. (TOP OF DOOR TO TOP OF FRAME) REMARKS
			ELEV.	MATL.	THK.	FINISH	MATL.	THK.	FINISH	ELEV.				TYPE	RM#	
	A200A	2'-4" x 7'-5 1/2"	A	WD.	1-3/4"	TRANS.	EXIST.	EXIST.	EXIST.	A		20 MIN	1	C3/F8	A200A	
	A200B	2'-4" x 7'-5 1/2"	A	WD.	1-3/4"	TRANS.	EXIST.	EXIST.	EXIST.	A		20 MIN	1	C3/F8	A200B	
	A200C	2'-4" x 7'-5 1/2"	A	WD.	1-3/4"	TRANS.	EXIST.	EXIST.	EXIST.	A		20 MIN	1	C3/F8	A200C	
	A200D	2'-4" x 7'-5 1/2"	A	WD.	1-3/4"	TRANS.	EXIST.	EXIST.	EXIST.	A		20 MIN	1	C3/F8	A200D	
	A200E	3'-0" x 7'-0"	A	H.M.	1-3/4"	PT.	EXIST.	EXIST.	EXIST.	A		20 MIN	1	C3/F8	A200E	
	A200F	2'-0" x 6'-8"	A	WD.	1-3/4"	TRANS.	EXIST.	EXIST.	EXIST.	A		20 MIN	2	C10		9 1/2"
	A200G	2'-0" x 6'-8"	B	WD.	1-3/4"	TRANS.	EXIST.	EXIST.	EXIST.	A		20 MIN	2	C10		9 1/2"
	A201A	2'-4" x 7'-5 1/2"	A	WD.	1-3/4"	TRANS.	EXIST.	EXIST.	EXIST.	A		20 MIN	1	C3/F8	A201A	
	A201B	2'-4" x 7'-5 1/2"	A	WD.	1-3/4"	TRANS.	EXIST.	EXIST.	EXIST.	A		20 MIN	1	C3/F8	A201B	
	A201C	2'-4" x 7'-5 1/2"	A	WD.	1-3/4"	TRANS.	EXIST.	EXIST.	EXIST.	A		20 MIN	1	C3/F8	A201C	
	A201D	2'-4" x 6'-8"	A	WD.	1-3/4"	TRANS.	EXIST.	EXIST.	EXIST.	A		20 MIN	1	C3/F8	A201D	9 1/2"
	A201E	2'-0" x 6'-8"	A	WD.	1-3/4"	TRANS.	EXIST.	EXIST.	EXIST.	A		20 MIN	2	C10		9 1/2"
	A201F	2'-0" x 6'-8"	B	WD.	1-3/4"	TRANS.	EXIST.	EXIST.	EXIST.	A		20 MIN	2	C10		9 1/2"

NOTE: ALL GREY BOXES SHALL INDICATE A DOOR THAT IS ASSOCIATED WITH ALTERNATE #2

**SECOND FLOOR DOOR, FRAME & SIGNAGE SCHEDULE CONT.**

NOTE: PRIOR TO ORDERING OF ANY UNITS ALL DIMENSIONS SHALL BE FIELD VERIFIED

ALTERNATE	NUMBER	SIZE	DOOR				FRAME				TRANSOM	DOOR RATING	HDWR.	SIGN		TRANSOM HT. (TOP OF DOOR TO TOP OF FRAME) REMARKS
			ELEV.	MATL.	THK.	FINISH	MATL.	THK.	FINISH	ELEV.				TYPE	RM#	
	A202A	2'-0" x 6'-8"	B	WD.	1-3/4"	TRANS.	EXIST.	EXIST.	EXIST.	A		20 MIN	3	C7	A202A	9 1/2"
	A202B	2'-0" x 6'-8"	B	WD.	1-3/4"	TRANS.	EXIST.	EXIST.	EXIST.	A		20 MIN	3	C7	A202B	9 1/2"
	A202C	EXISTING TO REMAIN	EXIST.	EXIST.	EXIST.	EXIST.	EXIST.	EXIST.	EXIST.	EXIST.	EXIST.	EXIST.	EXIST.	H3/F8/C9		DOORS TO STAIRS PREVIOUSLY REPLACED
	A202D	EXISTING TO REMAIN	EXIST.	EXIST.	EXIST.	EXIST.	EXIST.	EXIST.	EXIST.	EXIST.	EXIST.	EXIST.	EXIST.	H3/F8/C9		DOORS TO STAIRS PREVIOUSLY REPLACED
	B200A	2'-4" x 7'-0 1/2"	A	WD.	1-3/4"	TRANS.	EXIST.	EXIST.	EXIST.	A		20 MIN	1	C3/F8	B200A	9 1/2"
	B200B	2'-4" x 7'-0 1/2"	A	WD.	1-3/4"	TRANS.	EXIST.	EXIST.	EXIST.	A		20 MIN	1	C3/F8	B200B	9 1/2"
	B200C	2'-4" x 7'-0 1/2"	A	WD.	1-3/4"	TRANS.	EXIST.	EXIST.	EXIST.	A		20 MIN	1	C3/F8	B200C	9 1/2"
	B200D	2'-4" x 7'-0 1/2"	A	WD.	1-3/4"	TRANS.	EXIST.	EXIST.	EXIST.	A		20 MIN	1	C3/F8	B200D	9 1/2"
	B200E	2'-0" x 6'-8"	B	H.M.	1-3/4"	TRANS.	EXIST.	EXIST.	EXIST.	A		20 MIN	2	C10		9 1/2"
	B200F	2'-0" x 6'-8"	B	WD.	1-3/4"	TRANS.	EXIST.	EXIST.	EXIST.	A		20 MIN	2	C10		9 1/2"
	B201A	2'-4" x 7'-5 1/2"	A	WD.	1-3/4"	TRANS.	EXIST.	EXIST.	EXIST.	A		20 MIN	1	C3/F8	B201A	
	B201B	2'-4" x 7'-0 1/2"	A	WD.	1-3/4"	TRANS.	EXIST.	EXIST.	EXIST.	A		20 MIN	1	C3/F8	B201B	9 1/2"
	B201C	2'-4" x 7'-5 1/2"	A	WD.	1-3/4"	TRANS.	EXIST.	EXIST.	EXIST.	A		20 MIN	1	C3/F8	B201C	
	B201D	2'-4" x 7'-5 1/2"	A	WD.	1-3/4"	TRANS.	EXIST.</									







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 KINGSTON, RI**




Issues	Date	Description

Revisions	No.	Date	Description


Drawing Title  
**DEMOLITION FLOOR PLANS - PLUMBING**

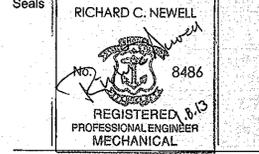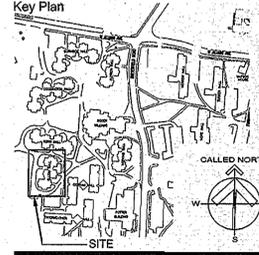Issue Date:	10/20/2012
Project No:	URI12IN Scale: AS NOTED
Project Manager:	WMS Production Leader: MS
Project Architect:	MT Peer Reviewer: RCN

Drawing Number  
**P1.101**

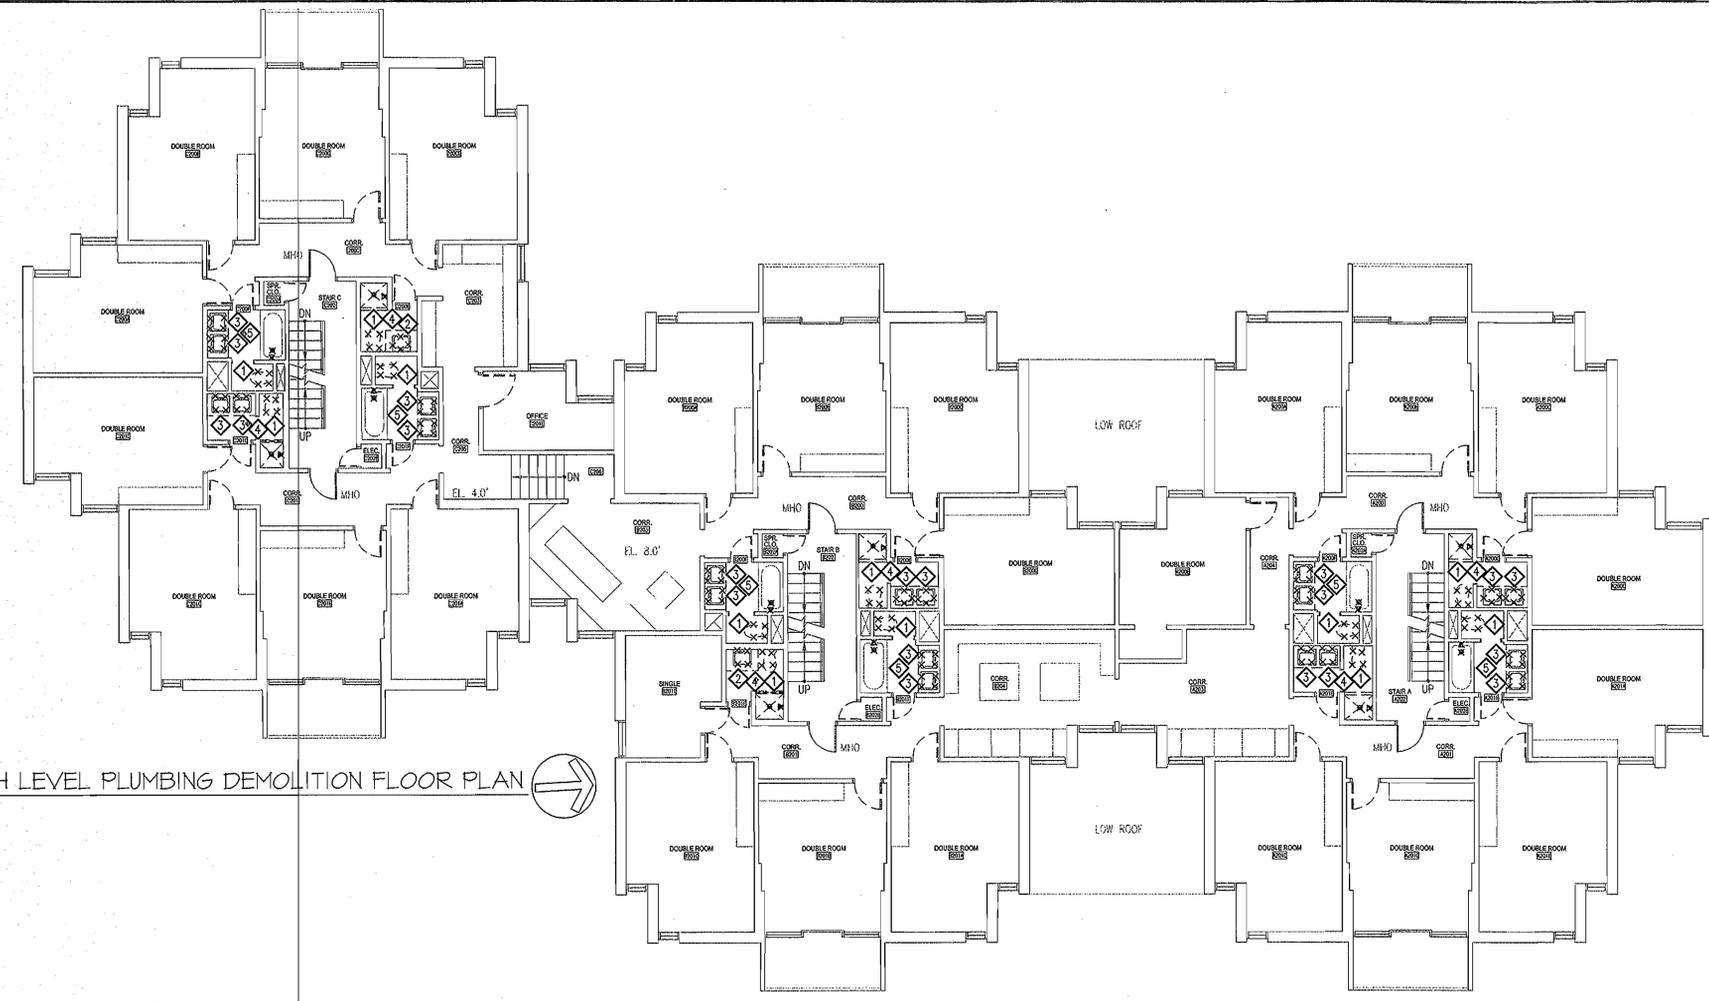

**210 SECOND, THIRD & FOURTH LEVEL PLUMBING DEMOLITION FLOOR PLAN**  
 SCALE: 1/8"=1'-0"

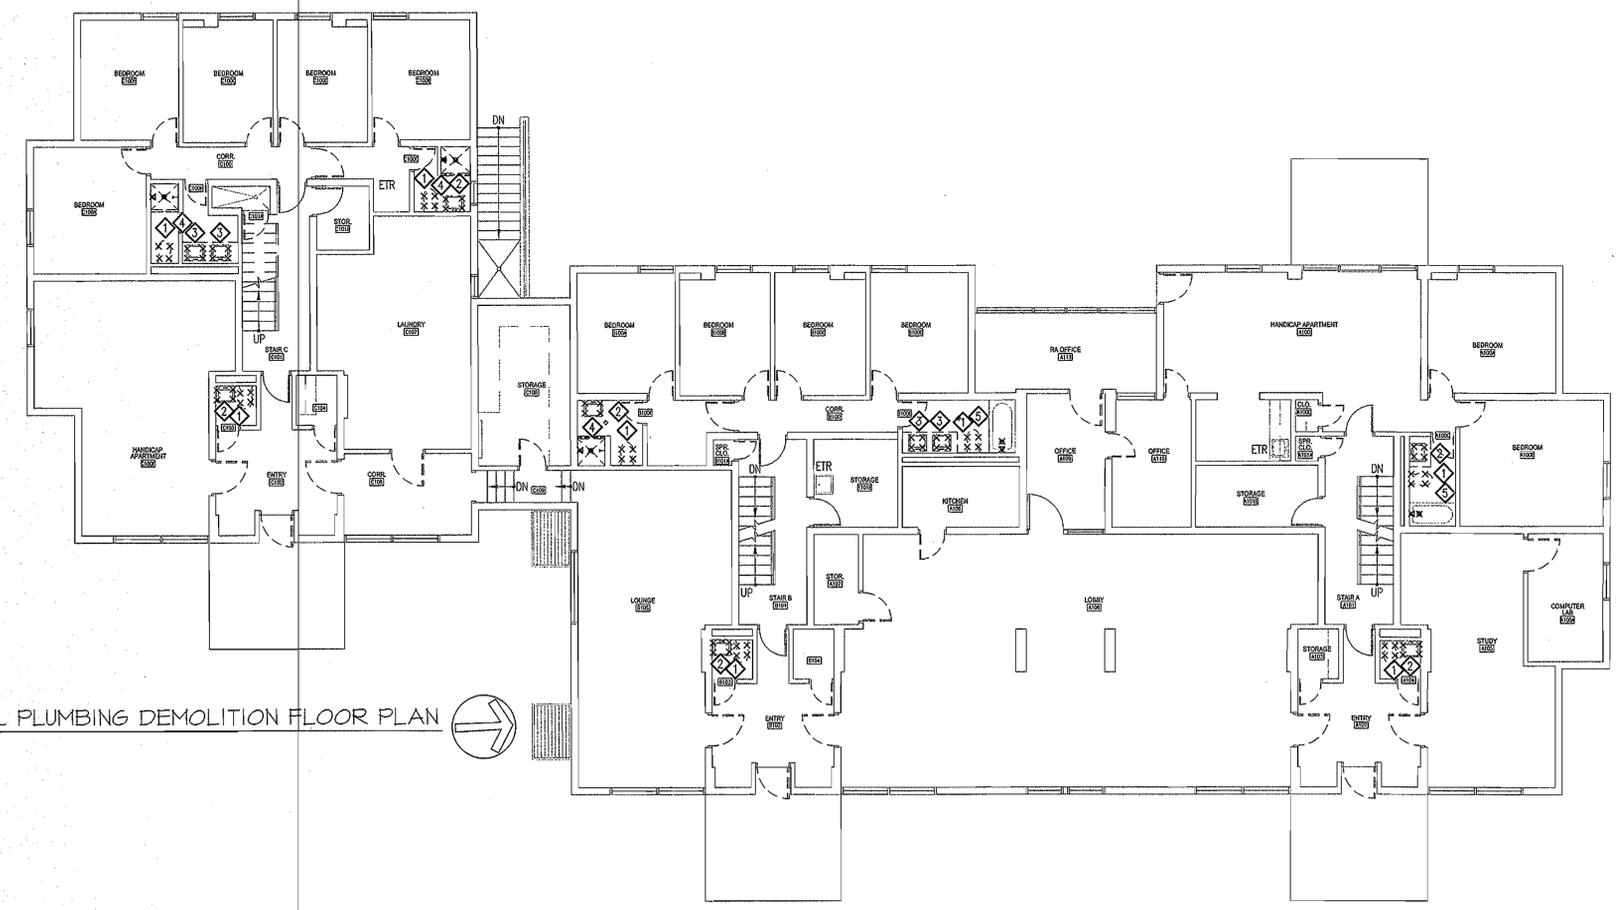

**210 GROUND LEVEL PLUMBING DEMOLITION FLOOR PLAN**  
 SCALE: 1/8"=1'-0"

**GENERAL DEMOLITION NOTES:**

1. THE CONTRACTOR RESPONSIBLE FOR THE DEMOLITION OF THE EXISTING PLUMBING FIXTURES, EQUIPMENT AND PIPING SHALL BE REQUIRED TO VISIT THE PROJECT SITE TO FAMILIARIZE THEMSELVES WITH THE FULL EXTENT OF WORK REQUIRED. VERIFY FIXTURE TYPES, QUANTITIES AND LOCATIONS. VERIFY WALL, CEILING AND FLOOR CONSTRUCTION. VERIFY AS MUCH OF THE EXISTING PIPING SYSTEM AS POSSIBLE. THIS FIELD VISIT SHALL BE CONDUCTED DURING THE BID PROCESS. BIDS SHALL BE BASED ON INFORMATION GATHERED DURING THIS VISIT.
2. REMOVE ALL PLUMBING FIXTURES INDICATED TO BE REMOVED. REMOVALS SHALL INCLUDE ANY TOILET FLANGES, SUPPLY RISERS, P-TRAPS, TAILPIECES, FLOOR DRAIN STRAINERS AND MIXING VALVES. THIS CONTRACTOR SHALL CAP OR PLUG WASTE AND WATER PIPING UNTIL NEW FIXTURES ARE RECONNECTED TO PREVENT ANY DEBRIS FROM ENTERING THE PIPING SYSTEMS. REMOVE ANY EXISTING PLUMBING WATER AND/OR WASTE PIPE FOUND TO BE ABANDONED. REFER TO NEW WORK DRAWINGS FOR NEW PLUMBING WORK.
3. THE PLUMBING CONTRACTOR SHALL BE RESPONSIBLE FOR ALL SAW CUTTING, CORING AND PATCHING REQUIRED FOR THE INSTALLATION OF NEW WORK, AND FOR THE REMOVAL OF EXISTING WORK. COORDINATE EXTENT OF THE LIMIT OF WORK BEFORE BIDS ARE ISSUED.
4. THE SITE SHALL BE LEFT BROOM CLEAN AND ALL DEBRIS SHALL BE REMOVED FROM THE SITE. PROTECT EXISTING PLUMBING FIXTURES TO REMAIN FROM DAMAGE DURING CONSTRUCTION.
5. ALL PIPING RENDERED OBSOLETE SHALL BE REMOVED AND CAPPED BACK AT THE NEAREST LIVE MAIN. DO NOT LEAVE ANY "DEAD-ENDED" SANITARY PIPING.
6. REMOVE EXISTING HANGERS, VALVES, INSULATION AND SUPPORTS ASSOCIATED WITH PIPING THAT IS BEING REMOVED.
7. EXISTING PLUMBING FIXTURES BEING REMOVED SHALL BE TURNED OVER TO OWNER. VERIFY WITH OWNER WHICH ITEMS ARE TO BE STORED AND WHERE, AND WHICH ITEMS ARE TO BE DISPOSED OF.

**DEMOLITION KEYED NOTES:**


- 1 DISCONNECT & REMOVE EXISTING WATER CLOSET, TOILET SEAT, ASSOCIATED CLOSET FLANGE, STOP, FLEXIBLE SUPPLY AND COLD WATER SUPPLY TO WALL FOR RECONNECTION. SEE NEW WORK DRAWINGS.
- 2 DISCONNECT & REMOVE EXISTING WALL HUNG LAVATORY, FAUCET, TAILPIECE, P-TRAP, POP-UP DRAIN, STOPS AND FLEXIBLE HOT AND COLD WATER SUPPLIES. CUT BACK PIPING TO WALL FOR RECONNECTION - SEE NEW WORK DRAWINGS.
- 3 DISCONNECT & REMOVE EXISTING COUNTERTOP LAVATORY, FAUCET, TAILPIECE, P-TRAP, POP-UP DRAIN, STOPS AND FLEXIBLE HOT AND COLD WATER SUPPLIES. CUT BACK PIPING TO WALL FOR RECONNECTION - SEE NEW WORK DRAWINGS.
- 4 DISCONNECT & REMOVE EXISTING SHOWER CONTROLS, MIXING VALVE, SHOWER HEAD, TRAP, FLOOR DRAIN BODY WITH STRAINER. CUT BACK WASTE AND VENT AND HOT AND COLD WATER TO WALL FOR RECONNECTION - SEE NEW WORK DRAWINGS.
- 5 DISCONNECT & REMOVE EXISTING SHOWER/TUB CONTROLS, MIXING VALVE, SHOWER HEAD, TUB DRAIN, AND STRAINER. CUT BACK WASTE AND VENT AND HOT AND COLD WATER TO WALL FOR RECONNECTION - SEE NEW WORK DRAWINGS.

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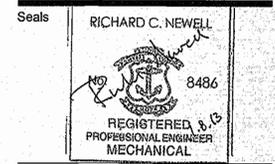
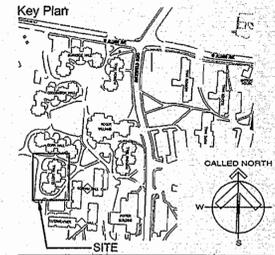
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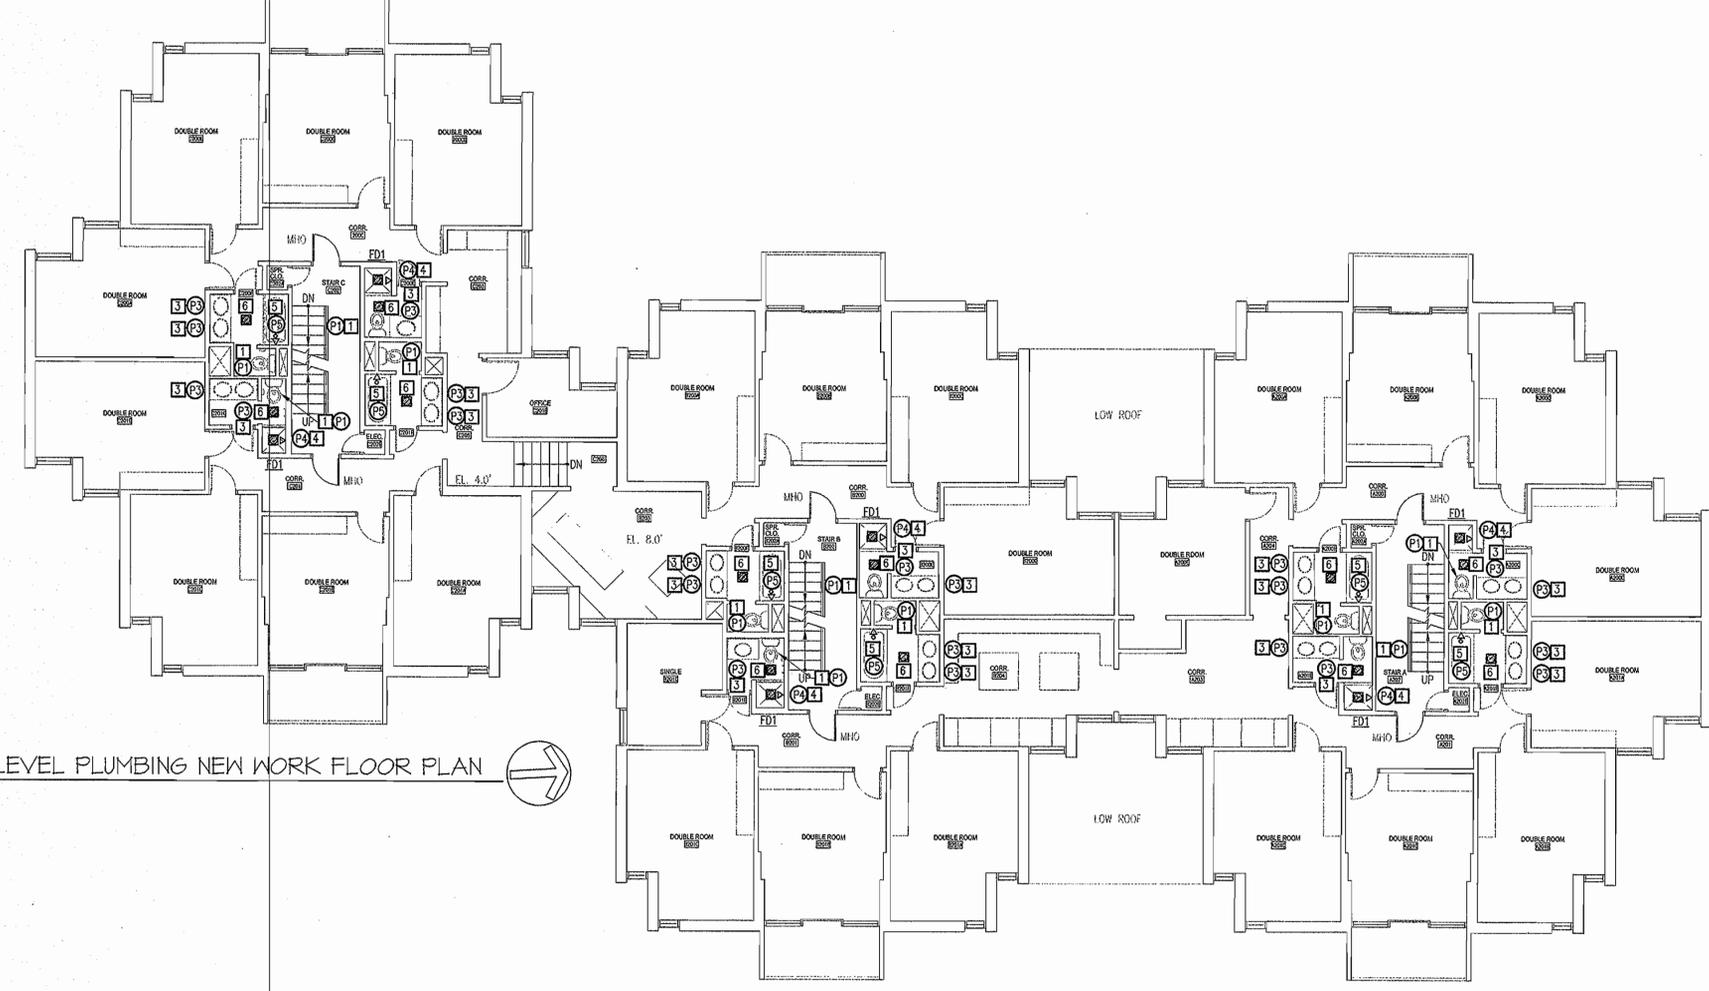
Issues	Date	Description

Revisions	No.	Date	Description


Drawing Title  
**NEW WORK  
 FLOOR PLANS -  
 PLUMBING**

Issue Date: 10/20/2012  
 Project No: URI12IN Scale: AS NOTED  
 Project Manager: WMS Production Leader: MS  
 Project Architect: MT Peer Reviewer: RCN

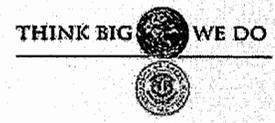Drawing Number  
**P2.101**  
 CEC# 201278



**D10 SECOND, THIRD & FOURTH LEVEL PLUMBING NEW WORK FLOOR PLAN**  
 SCALE: 1/8"=1'-0"

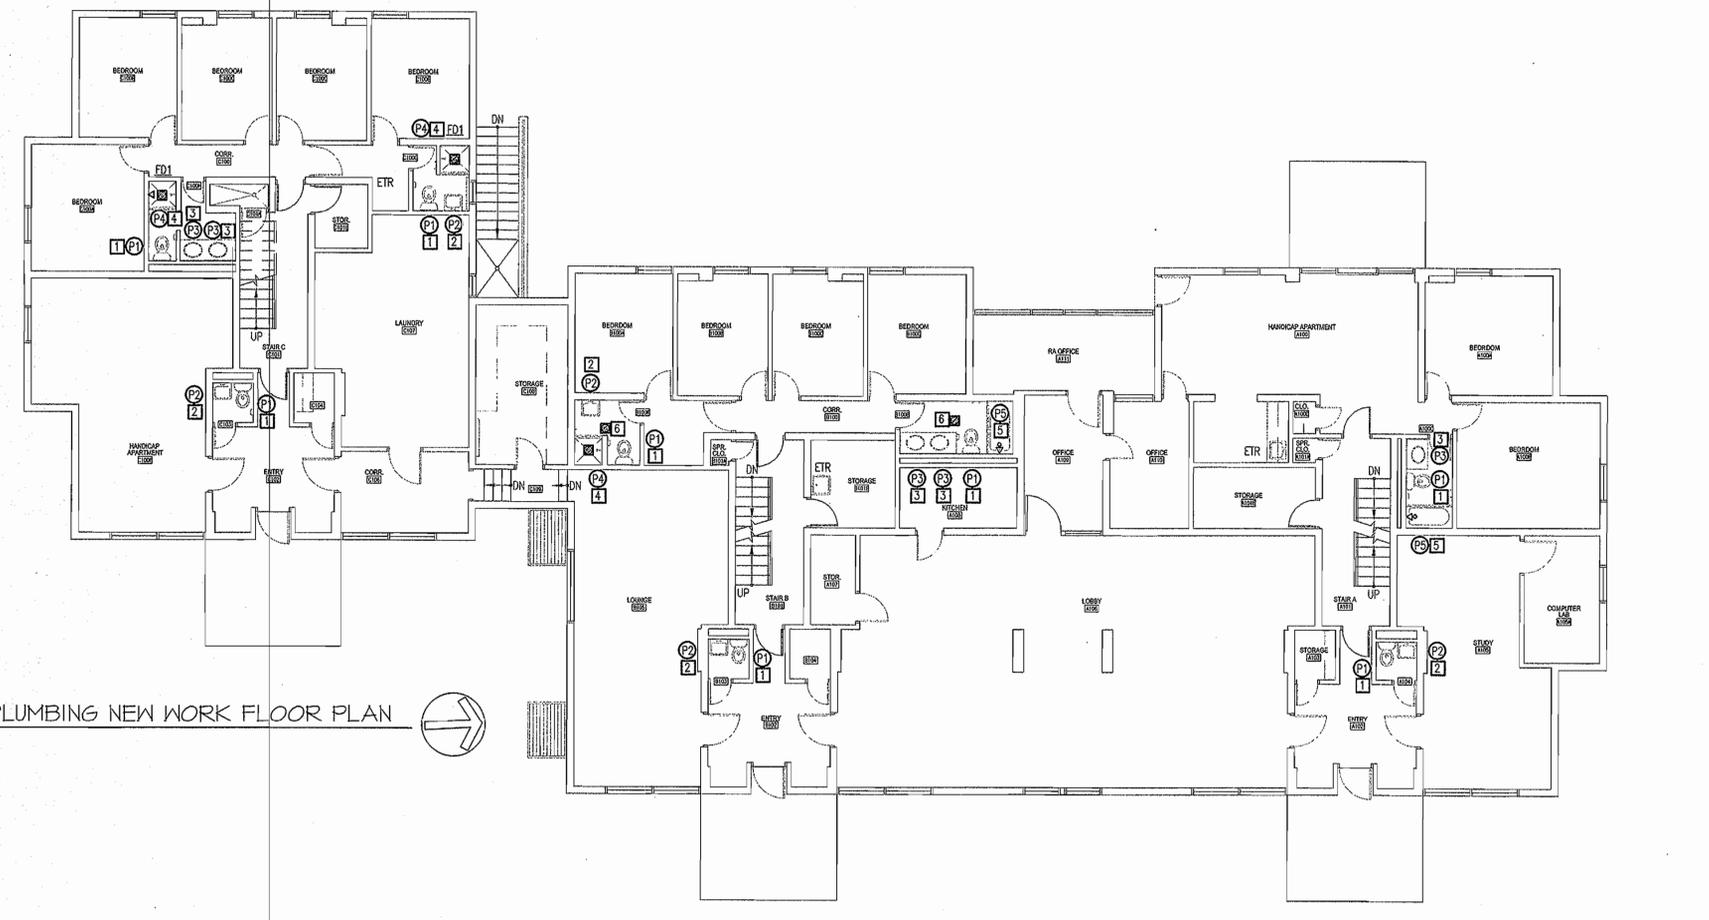

**H10 GROUND LEVEL PLUMBING NEW WORK FLOOR PLAN**  
 SCALE: 1/8"=1'-0"




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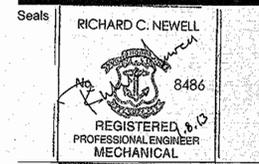


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 KINGSTON, RI**

Key Plan

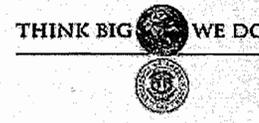

Issues	Date	Description

Revisions	No.	Date	Description

Drawing Title  
**LEGEND AND  
 SCHEDULES -  
 PLUMBING**

Issue Date: 10/20/2012  
 Project No: URI12IN Scale: AS NOTED  
 Project Manager: WMS Production Leader: MS  
 Project Architect: MT Peer Reviewer: RCN

Drawing Number  
**P3.101**  
 CEC# 201278

**PLUMBING FIXTURE SCHEDULE**

SYMBOL	DESCRIPTION	CONNECTIONS				FIXTURE	FITTINGS	REMARKS
		WASTE	VENT	HOT WATER	COLD WATER			
P1	TANK TYPE WATER CLOSET	4"	2"	-	1/2"	KOHLER # 3880	USE METAL CLOSET FLANGE - SECURE FLANGE TO CONCRETE FLOOR	VITREOUS CHINA, FLOOR MOUNTED, TANK TYPE WATER CLOSET WITH ROUND RIM WITH MATCHING ROUND SOFTCLOSE SEAT AND COVER #K-4658. 1.6 GALLON GALLONS PER FLUSH. PROVIDE "MCGUIRE" HEAVY DUTY STOP AND CHROME PLATED SUPPLY. VERIFY EXISTING ROUGH-IN WASTE DIMENSION MATCHES NEW ROUGH-IN WASTE DIMENSION BEFORE ORDERING FIXTURE.
P2	WALL HUNG LAVATORY	1-1/2"	1-1/2"	1/2"	1/2"	TOTO # LT307.4	SYMMONS # S-250-LWG	VITREOUS CHINA, WALL HUNG LAVATORY. CHROME PLATED, SINGLE LEVER, 4" CENTERS FAUCET FLOWING AT 2.2 GPM. PROVIDE POP UP DRAIN WITH LIFT ROD. PROVIDE "MCGUIRE" HEAVY DUTY STOPS, SUPPLIES, TRAP & TAILPIECE.
P3	COUNTERTOP LAVATORY	1-1/2"	1-1/2"	1/2"	1/2"	SOLID SURFACE COUNTER WITH INTEGRAL BOWL(S) (BY OTHERS)	SYMMONS # S-250-LWG	SOLID SURFACE COUNTER WITH INTEGRAL BOWL(S) (BY OTHERS). CHROME PLATED, SINGLE LEVER, 4" CENTERS FAUCET FLOWING AT 2.2 GPM. PROVIDE POP UP DRAIN. PROVIDE "MCGUIRE" HEAVY DUTY STOPS, SUPPLIES, TRAP & TAILPIECE.
P4	SHOWER	2"	2"	1/2"	1/2"	SHOWER BASE & SURROUND (BY OTHERS)	SYMMONS # S-96-1-X FD1 - SEE SCHEDULE	SHOWER BASE & SURROUND BY OTHERS. SHOWER CONTROLS WITH INTEGRAL STOPS.
P5	BATHTUB	2"	2"	1/2"	1/2"	BATHTUB & SURROUND (BY OTHERS)	SYMMONS # S-96-2-X WATCO # 501TL	BATHTUB & SURROUND BY OTHERS. SHOWER / BATHTUB CONTROLS WITH INTEGRAL STOPS AND DIVERTER. INCLUDE TRIP LEVER BATHTUB DRAIN.

**FLOOR DRAIN AND CLEANOUT SCHEDULE**

TYPE	SIZE	LOCATION	MODEL #	REMARKS
FD1	2"	SHOWERS AND ALTERNATE NO. 1	ZURN # ZN-415-S-EF-DP-VP	DURA-COATED CAST IRON BODY W/ BOTTOM OUTLET, 6" TYPE "S" DECORATIVE POLISHED NICKLE BRONZE STRAINER, VANDAL-PROOF SECURED TOP, COORDINATE INSTALLATION W/ COPPER PAN. ALTERNATE NO. 1 SHALL INCLUDE 2" "SURE SEAL" NEOPRENE TRAP SEAL SET IN FLOOR DRAIN.

**PLUMBING LEGEND**

SYMBOL	ABBR.	DESCRIPTION
=====	S/W	SOIL/WASTE PIPE BELOW SLAB
=====	V	VENT PIPE BELOW SLAB
=====	S/W	SOIL/WASTE PIPE ABOVE SLAB
-----	V	VENT PIPE ABOVE FLOOR SLAB
-----	CW	COLD WATER PIPE
-----	HW	HOT WATER PIPE
-----	HWR	HOT WATER RETURN PIPE
⊗		REMOVE EXISTING PLUMBING FIXTURE
⊕	FD	FLOOR DRAIN - SEE SCHEDULE
⊕	CTE	CONNECT TO EXISTING
P1		PLUMBING FIXTURE DESIGNATION
◇		DEMOLITION KEYED NOTE
□		NEW WORK KEYED NOTE
ETR		EXISTING TO REMAIN
VIF		VERIFY LOCATION, SIZE & FLOW IN FIELD
TYP		TYPICAL



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Issues

Date	Description

Revisions

No.	Date	Description



Drawing Title

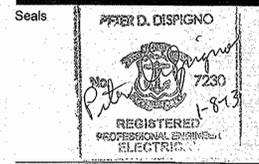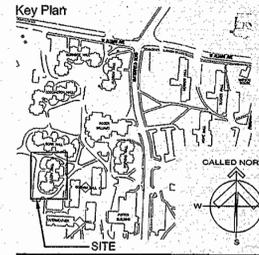**GROUND LEVEL ELECTRICAL PLAN**

Issue Date: 10/20/2012  
 Project No: URI12IN Scale: AS NOTED  
 Project Manager: WMS Production Leader: WMS  
 Project Architect: MT Peer Reviewer: PDS

Drawing Number  
**E2.101**

- SHEET NOTES:**
- 1 REMOVE EXISTING FIRE ALARM STROBE ONLY DEVICE AND BACKBOX, AND REINSTALL IN SAME LOCATION ON NEW SURFACE. PROVIDE ALL NECESSARY HARDWARE AND ALL FINAL TERMINATIONS.
  - 2 REMOVE EXISTING WALL MOUNTED 4' LINEAR FLUORESCENT AND REPLACE WITH NEW MERCURY LIGHTING #MP38-WW-232-AFW-ELB-HP-UNI. PROVIDE ALL NECESSARY HARDWARE AND ALL FINAL TERMINATIONS.
  - 3 REMOVE EXISTING SINGLE POLE WALL SWITCH AND COVERPLATE AND REPLACE WITH NEW. PROVIDE ALL NECESSARY HARDWARE AND ALL FINAL TERMINATIONS.
  - 4 REMOVE EXISTING SURFACE MOUNTED CEILING LIGHT FIXTURE AND REPLACE WITH NEW MERCURY LIGHTING #M66-213-PL-11-120V-TP-DL. PROVIDE ALL NECESSARY HARDWARE AND ALL FINAL TERMINATIONS.
  - 5 PROVIDE NEW GFI RECEPTACLE AND COVERPLATE IN NEW SURFACE MOUNTED IVORY WIREMOLD BOX. MOUNT AT 6" ABOVE COUNTERTOP. PROVIDE NEW (2)#12 & (1)#12G IN NEW SURFACE MOUNTED 500 SERIES STEEL IVORY WIREMOLD. FROM NEW LIGHT FIXTURE TO NEW GFI OUTLET. TERMINATE NEW WIRING TO EXISTING LIGHTING SWITCHLEG. PROVIDE ALL NECESSARY HARDWARE AND ALL FINAL TERMINATIONS.
  - 6 REMOVE EXISTING WALL MOUNTED 18" LINEAR FLUORESCENT AND REPLACE WITH NEW MERCURY LIGHTING #MP38-WW-217-AFW-ELB-HP-UNI. PROVIDE ALL NECESSARY HARDWARE AND ALL FINAL TERMINATIONS.
  - 7 REMOVE EXISTING GFI RECEPTACLE AND COVERPLATE, COUNTERTOP HEIGHT WIREMOLD BOX, AND (2)#12 & (1)#12G IN SURFACE MOUNTED WIREMOLD EXTENDING FROM EXISTING LIGHT FIXTURE, AND REPLACE WITH NEW. MOUNT NEW OUTLET AT 6" ABOVE COUNTERTOP. TERMINATE NEW WIRING TO EXISTING. PROVIDE ALL NECESSARY HARDWARE AND ALL FINAL TERMINATIONS.

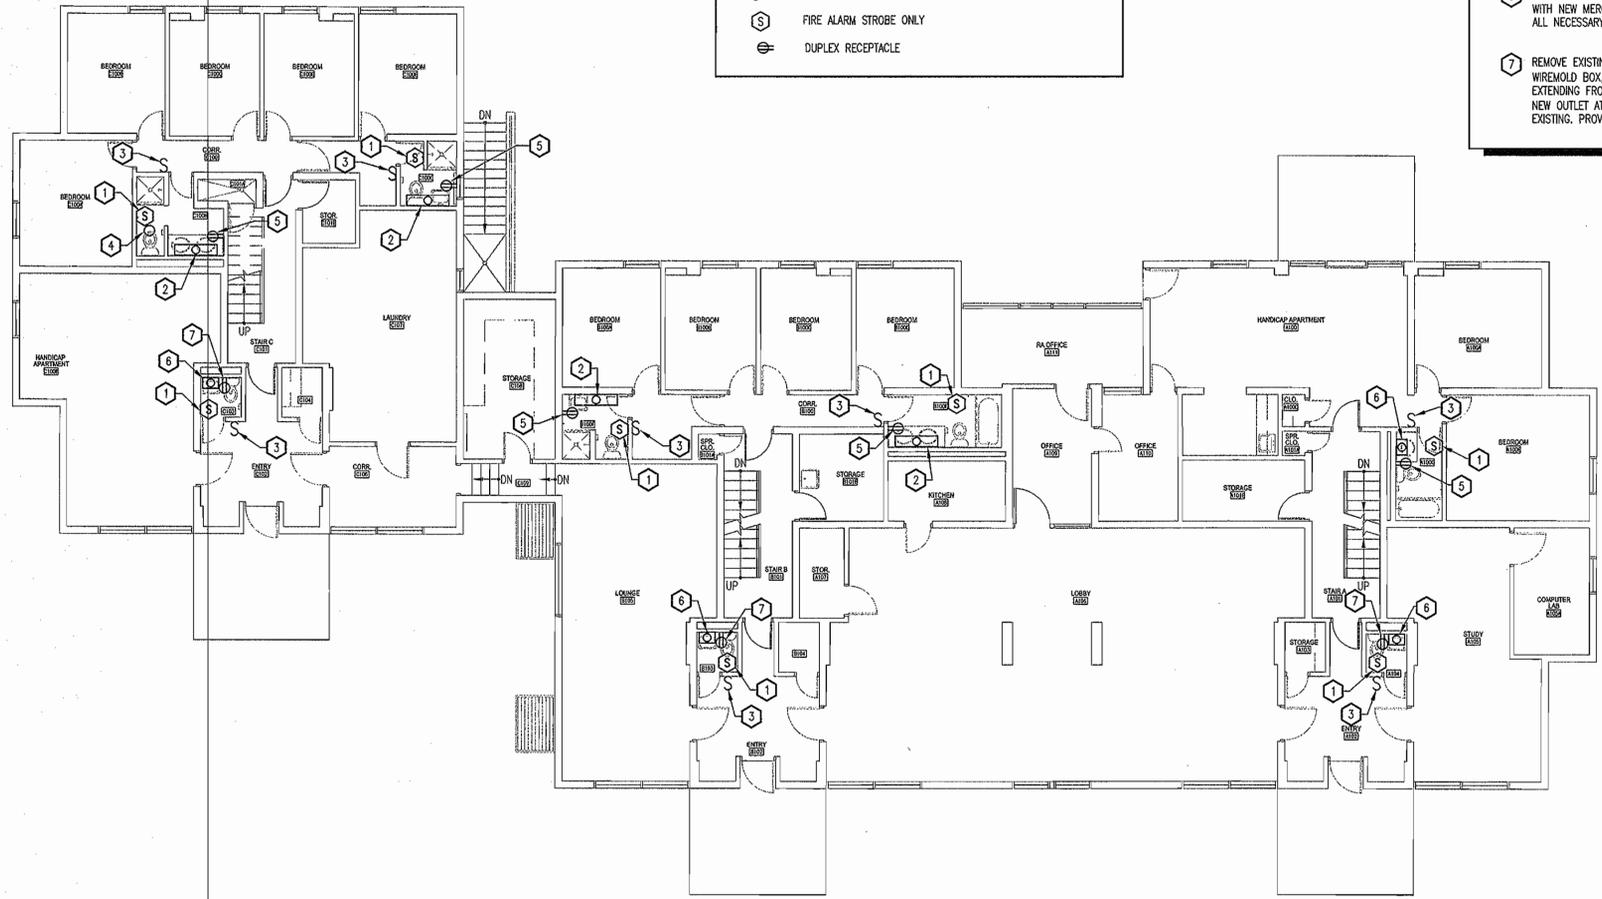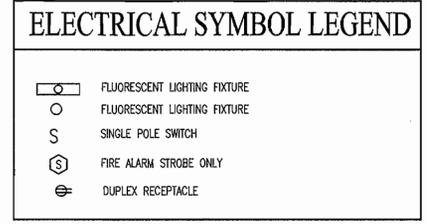

**G5 GROUND LEVEL ELECTRICAL PLAN**  
 SCALE: 1/8"=1'-0"

A  
B  
C  
D  
E  
F  
G  
H

10 | 9 | 8 | 7 | 6 | 5 | 4 | 3 | 2 | 1

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Consultant



Owner


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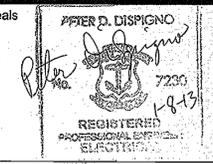


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Key Plan



Seals

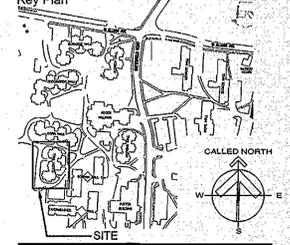

Issues	Date	Description

Revisions	No.	Date	Description

Drawing Title  
**SECOND THRU  
 FOURTH LEVEL  
 ELECTRICAL PLAN**


Issue Date: 10/20/2012  
 Project No: UH12IN Scale: AS NOTED  
 Project Manager: WMS Production Leader: WMS  
 Project Architect: MT Peer Reviewer: PDS

Drawing Number

**E2.102**

CEC# 201278

- SHEET NOTES:**
- 1 REMOVE EXISTING FIRE ALARM STROBE ONLY DEVICE AND BACKBOX, AND REINSTALL IN SAME LOCATION ON NEW SURFACE. PROVIDE ALL NECESSARY HARDWARE AND ALL FINAL TERMINATIONS.
  - 2 REMOVE EXISTING WALL MOUNTED 4' LINEAR FLUORESCENT AND REPLACE WITH NEW MERCURY LIGHTING #MF38-WW-232-AFW-ELB-HP-UNI. PROVIDE ALL NECESSARY HARDWARE AND ALL FINAL TERMINATIONS.
  - 3 REMOVE EXISTING SINGLE POLE WALL SWITCH AND COVERPLATE AND REPLACE WITH NEW. PROVIDE ALL NECESSARY HARDWARE AND ALL FINAL TERMINATIONS.
  - 4 REMOVE EXISTING SURFACE MOUNTED CEILING LIGHT FIXTURE AND REPLACE WITH NEW MERCURY LIGHTING #M66-213-PL-11-120V-TP-DL. PROVIDE ALL NECESSARY HARDWARE AND ALL FINAL TERMINATIONS.
  - 5 PROVIDE NEW GFI RECEPTACLE AND COVERPLATE IN NEW SURFACE MOUNTED IVORY WIREMOLD BOX. MOUNT AT 6" ABOVE COUNTERTOP. PROVIDE NEW (2)#12 & (1)#12G, IN NEW SURFACE MOUNTED 500 SERIES STEEL IVORY WIREMOLD, FROM NEW LIGHT FIXTURE TO NEW GFI OUTLET. TERMINATE NEW WIRING TO EXISTING LIGHTING SWITCHLEG. PROVIDE ALL NECESSARY HARDWARE AND ALL FINAL TERMINATIONS.

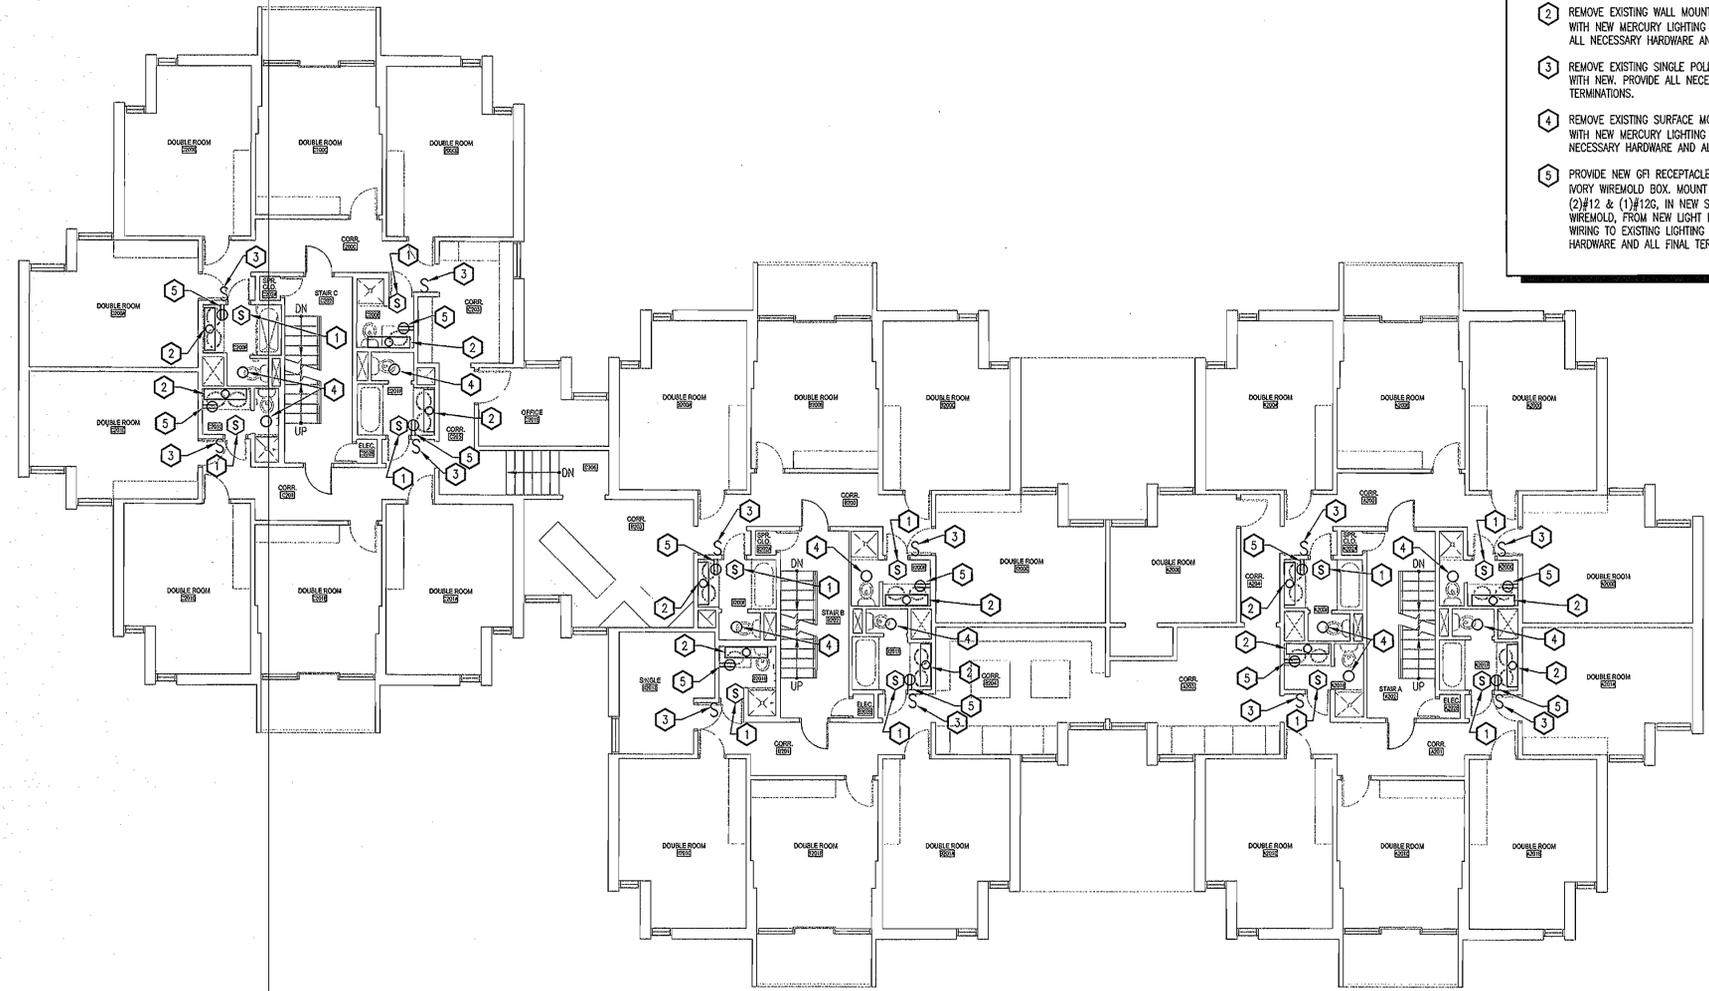

**G6** SECOND LEVEL ELECTRICAL PLAN-(THIRD & FOURTH LEVEL SIMILAR)  
 SCALE: 1/8"=1'-0"

A  
B  
C  
D  
E  
F  
G  
H

10 | 9 | 8 | 7 | 6 | 5 | 4 | 3 | 2 | 1